

Office Use Only			
Application No.:	Date Lodged:	1	1

Application for

	Planni	ng Per	mit				
Planning Enquiries	If you need help to c	complete this form, rea	d How to complete th	ne Application	n for Planning Permit form.		
Phone: 03 9205 2200 Web: http://www.hume.vic.gov.au	Any material submitted with this application, including plans and personal information, will be made available for public viewing, including electronically, and copies may be made for interested parties for the purpose of enabling consideration and review as part of a planning process under the <i>Planning and Environment Act 1987</i> . If you have any concerns, please contact Council's planning department.						
	A Questions mark	ed with an asterisk (*) a	re mandatory and mus	st be complete	ed.		
Clear Form	A If the space prov	vided on the form is ins	ufficient, attach a sepa	arate sheet.			
The Land 1 1 Addre	ss of the land. Comple	te the Street Address	and one of the For	mal Land D	escriptions.		
Street Address *	Unit No.:	St. No.: 12	St. Name: Balo	combe Cour	<u>*************************************</u>	7	
						1	
	Suburb/Locality: Cra	aigieburn			Postcode: 3064	j	
Formal Land Description *						7	
Complete either A or B.	A Lot No.:	OLodged Plan	Title Plan Plar	n of Subdivisi	ion No.:		
This information can be found on the certificate of	OR					4	
title.	B Crown Allotment	No ·		Section No).:		
uuo.		110				_	
uuc.	Parish/Township						
If this application relates		Name:	button and enter re	levant detail	s. Add Address		
If this application relates	to more than one addr	Name: ess, please click this					
If this application relates The Proposal A You may	to more than one addr	Name: ess, please click this	the information requ				
The Proposal A You male Insuffice 2 For what use, development or other matter do you	to more than one addr	Name: ess, please click this	the information required				
The Proposal A You mail Insuffic	to more than one addr	Name: ess, please click this ur proposal and attach on will delay your appl is application and descr	the information required		ss the application.		
If this application relates The Proposal A You may Insuffice 2 For what use, development or other matter do you require a permit? * If you need help about the proposal, read: How to Complete the Application for Planning	to more than one address give full details of you ient or unclear information. Select the focus of the Application for second provide addition by the planning second provide addition provide addition by the planning second provide addition provide addition provide addition by the planning second provide addition provide addition provide addition provide addition provide addition by the planning second provide addition provide additio	Name: ess, please click this ur proposal and attach on will delay your appl is application and descr and dwelling	the information required ication. Other Oposal, including: plan council or outlined in a	nired to asses	ss the application.		
If this application relates The Proposal A You may Insuffice 2 For what use, development or other matter do you require a permit? * If you need help about the proposal, read: How to Complete the Application for Planning	to more than one address give full details of you ient or unclear information. Select the focus of the Application for second provide addition by the planning second provide addition provide addition by the planning second provide addition provide addition provide addition by the planning second provide addition provide addition provide addition provide addition provide addition by the planning second provide addition provide additio	Name: ess, please click this ur proposal and attach on will delay your appl is application and descr and dwelling al information on the proscheme, requested by C	the information required ication. Other Oposal, including: plan council or outlined in a	ired to asses	es the application. The property of the prope		

Existing Conditions II		
Describe how the land is used and developed now * eg. vacant, three dwellings,	Residentila house	
medical centre with two		
practitioners, licensed restaurant with 80 seats, grazing.	Provide a plan of the existing condition	ns. Photos are also helpful.
Title Information ii		
5 Encumbrances on title *		an encumbrance on title such as a restrictrive covenant, ion such as an easement or building envelope?
If you need help about the title, read: How to complete the Application for Planning Permit		ce on how to proceed before continuing with this application.)
form	Not applicable (no such encumbrance)	e applies).
		for each individual parcel of land forming the subject site. er search statement', the title diagram and the associated title p. restrictive covenants.)
Applicant and Owner 6 Provide details of the applicant as Applicant * The person who wants		Surname: Popelier
the permit.	Organisation (if applicable): Pop Design	Studios
	Postal Address:	If it is a P.O. Box, enter the details here:
	Unit No.: St. No.: 145	St. Name: The Boulevard
	Suburb/Locality: Shepparton	State: VIC Postcode: 3630
Where the preferred contact person for the application is different from the applicant,	Contact person's details * Name:	Same as applicant (if so, go to 'contact information')
provide the details of that person.	Title: First Name:	Surname:
porson.	Organisation (if applicable):	
	Postal Address:	If it is a P.O. Box, enter the details here:
	Unit No.: St. No.:	St. Name:
	Suburb/Locality:	State: Postcode:
Please provide at least one	Contact information	
contact phone number *	Business Phone: 03 58 217444	Email: ron@popds.com.au
	Mobile Phone: 0417 217444	Fax:

Owner *	Name:			Same as applicant		
The person or organisation who owns the land	Title: Mr ▼	First Name: Ali	Surnam	e: Al-Khafaji		
Where the owner is different	Organisation (if applicable):					
from the applicant, provide	Postal Address:		If it is a P.O. Box, e	enter the details here:		
the details of that person or organisation.	Unit No.:	St. No.:	St. Name: Saxo	on Street		
	Suburb/Locality	y: Numurkah	State: VIC	Postcode: 3636		
	Owner's Signa	ture (Optional):		Date:		
				day / month / year		
eclaration ii This form must be signed by th	e applicant *	/				
Remember it is against the law to provide false or misleading information,			t all the information in this been notified of the perm			
which could result in a	Signature:			Date: 1.3.2021		
heavy fine and cancellation of the permit.	-	-		day / month / year		

8 Has there been a pre-application meeting	No	If 'yes', with whom?:					
with a Council planning officer?		Date:		day / month / year			
Checklist ii							
9 Have you:	Filled in the form o	completely?					
	Paid or included th	ne application fee?	Most application determine the a	ns require a fee to be paid. Contact Council to			
	Provided all neces	ssary supporting inform	nation and documen	ts?			
	A full, current cop	by of title information for ea	ch individual parcel of la	nd forming the subject site			
	A plan of existing	conditions.					
		e layout and details of the		anii ana saliinad ia a a sasa la la aniina a a sasa la la aniina a a sasa la aniina a a sasa la aniina a a sasa			
	checklist.			ncil or outlined in a council planning permit			
	If required, a description of the likely effect of the proposal (eg traffic, noise, environmental impacts).						
	If applicable, a current Metropolitan Planning Levy certificate (a levy certificate expires 90 days after the day on which it is issued by the State Revenue Office and then cannot be used). Failure to comply means the application is void.						
	Completed the relevant Council planning permit checklist?						
	Signed the declara	ation (section 7)?					
Lodgement ii							
Lodge the completed and signed form, the fee payment and all documents with:	Hume City Council PO Box 119 Dallas VIO Pascoe Vale Road Bro		7				
	Contact information:						
	Telephone: 61 03 9205 2200						
	Email: email: email@hume.vic.gov.au DX: 94718 Translation: 03 9205 2200 for connection to Hume Link's multilingual telephone information service						
	Deliver application in person, by fax, or by post:						
	Deliver application in		Print Form Make sure you deliver any required supporting information and necessary paymer when you deliver this form to the above mentioned address. This is usually your local council but can sometimes be the Minister for Planning or another body.				
		Make sure you delive when you deliver this	s form to the above r	mentioned address. This is usually you			
		Make sure you delive when you deliver this local council but can	s form to the above r sometimes be the N	mentioned address. This is usually you			

Application for Planning Permit 2007

VIC. Aus

process under the Planning and Environment Act 1987.

Need help with the Application? II



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REGISTER SEARCH STATEMENT (Title Search) Transfer of Land Act 1958

Page 1 of 1

VOLUME 09623 FOLIO 826

Security no: 124088494151J Produced 04/03/2021 03:07 PM

LAND DESCRIPTION

Lot 49 on Plan of Subdivision 146168K. PARENT TITLE Volume 09567 Folio 754 Created by instrument LP146168K 31/07/1985

REGISTERED PROPRIETOR

Estate Fee Simple Sole Proprietor ALI ABBAS ABDUL-AMIR AL-KHAFAJI of 78 SAXTON STREET NUMURKAH VIC 3636 AQ606818H 05/01/2018

ENCUMBRANCES, CAVEATS AND NOTICES

MORTGAGE AQ606819F 05/01/2018 WESTPAC BANKING CORPORATION

Any encumbrances created by Section 98 Transfer of Land Act 1958 or Section 24 Subdivision Act 1988 and any other encumbrances shown or entered on the plan or imaged folio set out under DIAGRAM LOCATION below.

DIAGRAM LOCATION

SEE LP146168K FOR FURTHER DETAILS AND BOUNDARIES

ACTIVITY IN THE LAST 125 DAYS

NIL

------END OF REGISTER SEARCH STATEMENT--------

Additional information: (not part of the Register Search Statement)

Street Address: 12 BALCOMBE COURT CRAIGIEBURN VIC 3064

ADMINISTRATIVE NOTICES

NIL

eCT Control 16320Q WESTPAC BANKING CORPORATION Effective from 08/01/2018

DOCUMENT END

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PLAN OF SUBDIVISION PART OF CROWN SECTION 16 PARISH OF YUROKE COUNTY OF BOURKE VOL 9567 FOL 754

Measurements are in Metres

BLUE- DRAINAGE AND SEWERAGE

NOTATIONS

LOTS I TO 24 AND 35 TO 38 (ALL INCLUSIVE) HAYE BEEN OMITTED FROM THIS PLAN. BROWN HATCHED-(ENCUMBERED) WAY, DRAINAGE AND SENERAGE VIDE L.R. 145544

APPROPRIATIONS

WN HATCHED-WAY, DRAINAGE

YELLOW-: MIPLIED EASEMENT FOR WAY, DRAINAGE AND SEWERAGE PURPOSES YIDE LR 14585

LP 146168K

PLAN APPROVED 31/07/85.

2 SHEETS SHEET


COLOUR CODE

E-1 = BLUE


E-2 = BROWN

E-3 = BROWN HATCHED

E-4 = A-1

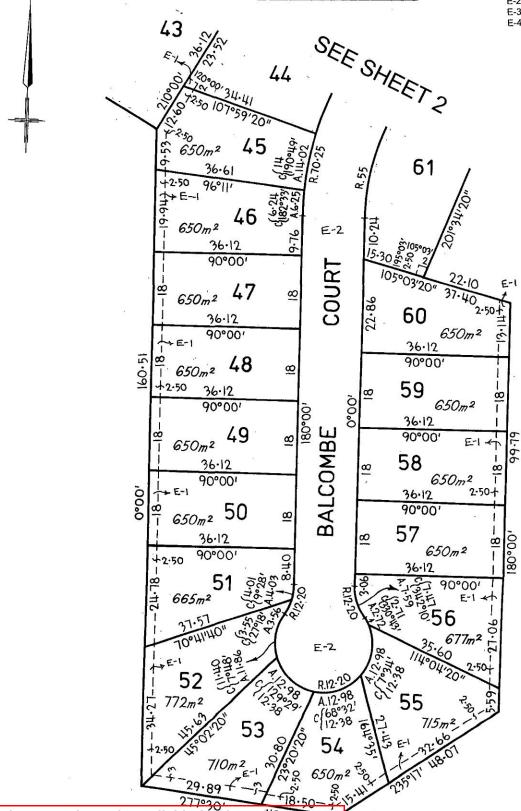



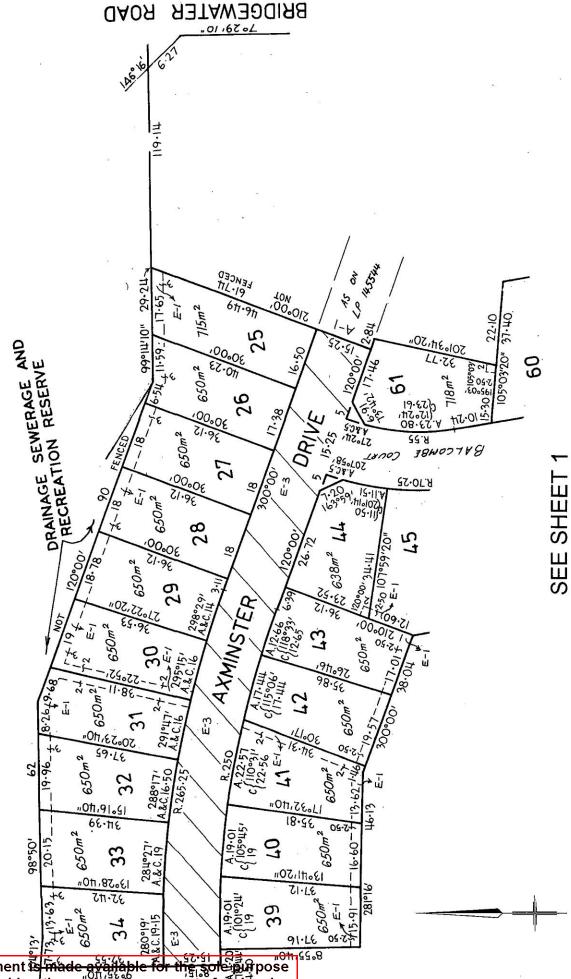

T 03] 5821 7444 F 03] 5821 2047 122 High Street PO Box 1090 Shepparton Vic 3630 ron@popds.com.au www.popds.com.au

12 Balcombe Court Craigieburn

Clause 55

Clause 55.02.1 Neighbourhood character

Our proposed development is located to the rear of the site with an existing residence located to the front facing the street. Our proposed unit is located 1.2, 3.1 at rear and on the boundary on the southern side. The unit will have minimum visibility from the street. The general amenity of the homes and units within the court are brick veneer buildings with tiled roofs. Our development will reflect the general architecture of the court

Clause 55.02.2 Residential Policy

We believe that this development is in keeping with State and Local planning policy framework

Our proposal is single storey residence and is located behind an existing residence which is facing the
street. The proposed building has no shadowing impact on surrounding residences as it is a single
storey with 1.8 m high boundary fences

Clause 55.02.3 Dwelling Diversity

Our development is a three bedroom residence which has an area of 167 m2 which includes garage.

Clause 55.02.4 Infrastructure

The existing site has an existing residence located to the front of the site.

Our proposed building is located at the rear of the site and we will be connecting into the existing sewer and stormwater drainage system. We will also connect water to the site from the existing water main.



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Clause 55.02.3 Integration with the street

Our development has a driveway which connects to the street. We also have access from the front to our front door via the new driveway. There is a front fence to the site.

Clause 55.03.1 Street Setbacks.

Our development is located at the rear of the site thus not impeding on any front setbacks

Clause 55.03.2 Building height

Our development is single storey which is in keeping with the existing Neighbourhood Character

Clause 55.03.3 Site Coverage

Our site has an area of 650.16 m2. The existing residence, new car port and our proposed building has a coverage of 313 m2. This gives a site coverage of 48.14 %

Clause 55.03.4 Permeability

Our non-impervious area is 225.8 m2. Our buildings and driveways come to 424.36 m2 thus giving Us a 34.73 % permeability of the site. This is not applicable as we are doing a 2 lot subdivision and we will be under the 400 m2 block size

Clause 55.03.5 Energy efficiency

We have orientated the building to have living and kitchen facing west due to the design constraints

We have also located the private outdoor space to the west



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Clause 55.03.6 Open space

There are no communal open spaces. Each dwelling has its own private open space

Clause 55.03.7 Safety

Our development has the front door facing the street and is visible from the driveway

Clause 55.03.8 Landscaping

Our development has proposed landscaping which will compliment both the existing residence and the proposed new Unit. There are no large trees that will need to be removed apart from a pine tree where the proposed garage is located

Clause 55.03.9 Access

We have used a portion of the existing driveway and extended it to accommodate the proposed new carports. The layout allows for the reversing from the site

Clause 55.03.10 Parking location

Our development allows for the parking of cars in the proposed carport. There is one carspace for each Residence located in front of carport and garage

Clause 55.04.1 Side and rear setback

Our proposed unit is located away from any boundaries apart from the southern boundary. We have setbacks of 1.2 m , 3.1 m and garage and family room are located on the boundary



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Clause 55.04.2 Walls on boundaries

We have garage and family room walls to the rear residence on the boundary. The length of wall on boundary is 11.861 m. We are permitted to have 10 m plus ¼ of the remaining distance

This means that we can have 16.53 m. We have 11.861 m. Our wall on the boundary is 2.9 m high

Clause 55 .04.3 Daylight to windows

Our development has no impact on any existing neighbours windows

Clause 55.04.4 North facing windows

Our development is not located within 3 m of an existing north facing habitable window

Clause 55.04.5 Overshadowing open space

Our development has an impact on an existing secluded open space to the south of our proposed development. We have 1.8 m high fences around boundaries

Clause 55.04.6 Overlooking

Our proposed development is single storey, thus no overlooking issues

Clause 55.04.7 Internal viewing

Our proposed development will have no impact on the viewing into the existing dwellings secluded space



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Clause 55.04.8 Noise impacts

All mechanical plant will be located to the rear of the proposed unit thus having no impact on adjoining residence bedroom

Clause 55.05.1 Accessibility

We would allow for steps to gain access to the proposed residence

Clause 55.05.2 Dwelling entry

The proposed unit will have its own front door which will give it its own identity

Clause 55.05.3 Daylight to new windows

Our development has adequate daylight access to new windows as there are no obstructions

To these windows

Clause 55.05.5 Solar access to open space

Our development has the open private space to the west of our development

Clause 55.05.6 Storage

Our development will have a independent shed located on the site for storage location to be confirmed



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Clause 55.06.1 Design

Our development is a brick veneer home. Externally we will be providing a pitched roof over. We do have some protrusions to articulation the external elevations. The architectural design is reflected in the existing dwellings within the court. There is a 2 unit development opposite our proposed development

Clause 55.06.2 Front fences

There is a 1 m high wrought iron front fence to the site.

Clause 55.06.3 Common property

The only common property will be at the front where they will share a common concrete crossover

Clause 55.06.4 Site Services

Our design allows for easements for services. We have adequate area for bins etc. We will have a letter box to front of site







Residential Energy Solutions

SHAPING A SUSTAINABLE FUTURE

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Prepared for: Pop design studios **Assessment by**: Shaun Hills

process under the Planning and Environment Act 1987.

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Please note that the plan may not be to scale.



Date 17th November 2021 Our Reference [Job No.] 214908

Property Details			
Applicant Name	Pop design studio		
Property Description	Lot 000 on RP/SP 000000	Building Class	1
Site Address 12 Balo	combe Court Craigieburn VIC 3064	LGA HUM	E CITY COUNCIL
Traditional Place Name	Woiworung country		
Total Site Area	339.16m2	Number of Res. Dwellings	1

Management

Thermal performance modelled of standard/default reading

Water

Reticulated water- N/A

Tank water - N/A

Water fixtures / fittings - As per BESS report 4 WELS rated fittings used throughout

Washing machine water efficiency - based on use of 5-star WELS or greater unit

Energy

NatHERS - assumed 6-star rating 110.0 MJ/sqm heating, 27.6 MJ/sqm cooling

Heating - Reverse cycle space/ std/MEPS

Cooling - Refrigerative space/ std/MEPS

Hot Water - Gas storage/ 5-star

Clothes line - private outdoor clothesline

Stormwater

Storm score - 100%

IEQ

Cross flow - Achieved

Thermal comfort / Double glazing - Yes

Thermal comfort / External shading - Yes

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Transport

Bicycle parking / Residential - N/A

Electric vehicle infrastructure - N/A

Waste

Construction waste / building reuse - N/A

Operation Waste / Food & Garden Waste - FOGO service

Urban Ecology

Urban ecology / Vegetation – 24%

Urban ecology / Green roofs - N/A

Urban ecology / Green walls and façade - N/A

Urban ecology / Food production - Residential - 1.0m2

Innovation

This conied document

Innovation - N/A

Your summary was completed by our accredited assessor

SHAUN HILLS HERA000000

ONE**TREE**PLANTED

Shaun Hills

THANK YOU FOR COLLABORATING WITH US. ROUGH ONE TREE PLANTED WE JUST PLANTED A TREE TOGETHER!

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BESS Report

Built Environment Sustainability Scorecard










This BESS report outlines the sustainable design commitments of the proposed development at 12 Balcombe Ct Craigieburn VIC 3064. The BESS report and accompanying documents and evidence are submitted in response to the requirement for a Sustainable Design Assessment or Sustainability Management Plan at Hume City Council.

Note that where a Sustainability Management Plan is required, the BESS report must be accompanied by a report that further demonstrates the development's potential to achieve the relevant environmental performance outcomes and documents the means by which the performance outcomes can be achieved.

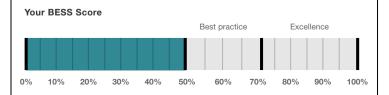

50%

Project details

Address 12 Balcombe Ct Craigieburn VIC 3064

Project no 9E0DDC22-R2

BESS Version BESS-6

Site type Single dwelling

Account shaun@seedhaus.com.au

Application no.

Site area 339 m²
Building floor area 167.0 m²

 Date
 23 November 2021

 Software version
 1.7.0-B.375



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Please note that the plan may not be to scale.

Dwellings & Non Res Spaces

Dwellings

Name	Quantity	Area	% of total area
Detached dwelling			
Dwelling	1	167 m²	100%
Total	1	167 m²	100%

Supporting information

Floorplans & elevation notes

Credit	Requirement	Response	Status
Water 3.1	Water efficient garden annotated		-
Energy 3.3	External lighting sensors annotated		-
Energy 3.4	Clothes line annotated (if proposed)		-
Stormwater 1.1	Location of any stormwater management systems used in STORM or MUSIC modelling (e.g. Rainwater tanks, raingarden, buffer strips)		-
IEQ 2.2	Dwellings meeting the requirements for having 'natural cross flow ventilation	ion'	-
IEQ 3.1	Glazing specification to be annotated		-
IEQ 3.2	Adjustable shading systems		-
Waste 2.1	Location of food and garden waste facilities		-
Urban Ecology 2.1	Vegetated areas		-
Urban Ecology 3.1	Food production areas		-

Supporting evidence

Credit	Requirement	Response	Status
Energy 3.5	Provide a written description of the average lighting power density to be installed in the development and specify the lighting type(s) to be used.		-
Stormwater 1.1	STORM report or MUSIC model		-
IEQ 2.2	A list of dwellings with natural cross flow ventilation		-
IEQ 3.1	Reference to floor plans or energy modelling showing the glazing specification (U-value and Solar Heat Gain Coefficient, SHGC)		-
IEQ 3.2	Reference to floor plans and elevations showing shading devices		-

Credit summary

Management Overall contribution 4.5%

Management Overall contribution 4.5%	0%
1.1 Pre-Application Meeting	0%
2.1 Thermal Performance Modelling - Single Dwelling	0%

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Water Overall contribution 9.0%

	Minimu	um re	quired 50%	50%	✓ Pass	
1.1 Potable water use reduction				40%		
3.1 Water Efficient Landscaping				100%		

Energy Overall contribution 27.5%

	Minimum	required 50% 50%	✓ Pass
1.2 Thermal Performance Rating - Residential		0%	
2.1 Greenhouse Gas Emissions		100%	
2.2 Peak Demand		0%	
2.3 Electricity Consumption		100%	
2.4 Gas Consumption		100%	
2.5 Wood Consumption		N/A	Scoped Out
		No wood	heating system present
3.2 Hot Water		100%	
3.3 External Lighting		100%	
3.4 Clothes Drying		100%	
3.5 Internal Lighting - Residential Single Dwelling		100%	
4.4 Renewable Energy Systems - Other		N/A	Ø Disabled
No other (non-solar PV) renewable energy is in use		ewable energy is in use.	
4.5 Solar PV - Houses and Townhouses		N/A	O Disabled
		No solar PV ren	ewable energy is in use.

Stormwater Overall contribution 13.5%

	Minimum required 100%	100% ✔ Pass
1.1 Stormwater Treatment		100%

IEQ Overall contribution 16.5%

	Minimum requir	red 50%	80%	✓ Pass
2.2 Cross Flow Ventilation			100%	
3.1 Thermal comfort - Double Glazing			100%	
3.2 Thermal Comfort - External Shading			100%	
3.3 Thermal Comfort - Orientation			0%	

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Transport Overall contribution 9.0%

			0%	
1.1 Bicycle Parking - Residential		0%		
	2.1 Electric Vehicle Infrastructure		0%	

Waste Overall contribution 5.5%

	50%	
1.1 - Construction Waste - Building Re-Use	0%	_
2.1 - Operational Waste - Food & Garden Waste	100%	

Urban Ecology Overall contribution 5.5%

	57%
2.1 Vegetation	75%
2.2 Green Roofs	0%
2.3 Green Walls and Facades	0%
3.1 Food Production - Residential	100%

Innovation Overall contribution 9.0%

		0%	
1.1 Innovation		0%	

Credit breakdown

Management Overall contribution 0%

1.1 Pre-Application Meeting		0%		
Score Contribution	This credit contributes 60.0% towards the category score.			
Criteria	Has an ESD professional been engaged to p	Has an ESD professional been engaged to provide sustainability advice from schematic		
	design to construction? AND Has the ESD p	rofessional been involved in a pre-		
	application meeting with Council?			
Question	Criteria Achieved ?			
Project	No			
2.1 Thermal Performance Modellin	ng - Single Dwelling	0%		
Score Contribution	This credit contributes 40.0% towards the ca	ategory score.		
Criteria	Has a preliminary NatHERS rating been under	ertaken?		
O ti	Ouit and a Alada and O			

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Water Overall contribution 4% Minimum required 50%

Water Approach				
What approach do you want to	use for Water?:	Use the built in calculation tools		
Project Water Profile Question				
Do you have a reticulated third precycling system?:	pipe or an on-site water	No		
Are you installing a swimming po	ool?:	No		
Are you installing a rainwater tar	nk?:	No		
Water fixtures, fittings and cor	nnections			
Showerhead:		4 Star WELS (>= 4.5 but <= 6.0)		
Bath:		Medium Sized Contemporary Bath		
Kitchen Taps:		>= 4 Star WELS rating		
Bathroom Taps:		>= 4 Star WELS rating		
Dishwashers:		>= 4 Star WELS rating		
WC:		>= 4 Star WELS rating		
Urinals:		Scope out		
Washing Machine Water Efficien	су:	>= 5 Star WELS rating		
1.1 Potable water use reduction	on	40%		
Score Contribution	This credit contrib	outes 83.3% towards the category score.		
Criteria	What is the reduct	tion in total potable water use due to efficient fixtures, appliances,		
	rainwater use and	recycled water use? To achieve points in this credit there must be		
	>25% potable wa	ter reduction.		
Output	Reference			
Project	214 kL	214 kL		
Output	Proposed (excludi	ing rainwater and recycled water use)		
Project	160 kL			
Output	Proposed (includia	ng rainwater and recycled water use)		
Project	160 kL			
Output	% Reduction in Po	otable Water Consumption		
Project	25 %			
Output	% of connected d	lemand met by rainwater		
Project	83 %			
Output	How often does the	ne tank overflow?		
Project	Often			
Output	Opportunity for ac	dditional rainwater connection		
Project	75 kL			
3.1 Water Efficient Landscapin	g	100%		
Score Contribution	This credit contrib	outes 16.7% towards the category score.		
Criteria	Will water efficient	t landscaping be installed?		
opied document is I	Criteria Achieved	2-4		

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Energy Overall contribution 14% Minimum required 50%

Dwellings Energy Approach		
What approach do you want to u	se for Energy?:	Use the built in calculation tools
Project Energy Profile Question	1	
Are you installing any solar photo	voltaic (PV) system(s)?:	No
Are you installing any other renev	vable energy system(s)?:	No
Gas supplied into building:		Natural Gas
Dwelling Energy Profile		
Below the floor is:		Ground or Carpark
Above the ceiling is:		Outside
Exposed sides:		4
NatHERS Annual Energy Loads -	Heat:	110 MJ/sqm
NatHERS Annual Energy Loads -	Cool:	27.6 MJ/sqm
NatHERS star rating:		6.0
Type of Heating System:		D Reverse cycle space
Heating System Efficiency:		std/MEPS
Type of Cooling System:		Refrigerative space
Cooling System Efficiency:		Current Default / MEPS
Type of Hot Water System:		F Gas Storage 5 star
Is the hot water system shared by multiple dwellings?:		No
% Contribution from solar hot wa	ter system:	0 %
Clothes Line:		D Private outdoor clothesline
Clothes Dryer:		A No clothes dryer
1.2 Thermal Performance Rating - Residential		0%
Score Contribution	This credit contrib	outes 30.0% towards the category score.
Criteria	What is the average	ge NatHERS rating?
Output	Average NATHERS	S Rating (Weighted)
Detached dwelling	6.0 Stars	
2.1 Greenhouse Gas Emissions		100%
Score Contribution	This credit contrib	outes 10.0% towards the category score.
Criteria	What is the % red	luction in annual greenhouse gas emissions against the benchmark?
Output	Reference Building	g with Reference Services (BCA only)
Detached dwelling	8,452 kg CO2	
Output	Proposed Building	g with Proposed Services (Actual Building)
Detached dwelling	3,623 kg CO2	
Output	% Reduction in G	HG Emissions
Detached dwelling	57 %	

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2.2 Peak Demand	0%
Score Contribution	This credit contributes 5.0% towards the category score.
Criteria	What is the % reduction in instantaneous (peak-hour) demand against the benchmark?
Dutput	Peak Thermal Cooling Load - Baseline
Detached dwelling	23.2 kW
Dutput	Peak Thermal Cooling Load - Proposed
Detached dwelling	23.2 kW
Dutput	Peak Thermal Cooling Load - % Reduction
Detached dwelling	0 %
2.3 Electricity Consumption	100%
Score Contribution	This credit contributes 10.0% towards the category score.
	What is the % reduction in annual electricity consumption against the benchmark?
Dutput	Reference
Detached dwelling	7,331 kWh
Output	Proposed
Detached dwelling	2.767 kWh
Output	Improvement
Detached dwelling	62 %
2.4 Gas Consumption	100%
Score Contribution	This credit contributes 10.0% towards the category score.
Criteria	What is the % reduction in annual gas consumption against the benchmark?
Dutput	Reference
Detached dwelling	18,968 MJ
Dutput	Proposed
Detached dwelling	15,579 MJ
Dutput	Improvement
Detached dwelling	17 %
2.5 Wood Consumption	N/A
Γhis credit was scoped out	No wood heating system present
3.2 Hot Water	100%
Score Contribution	This credit contributes 5.0% towards the category score.
 Criteria	What is the % reduction in annual energy consumption (gas and electricity) of the hot
	water system against the benchmark?
Dutput	Reference
Detached dwelling	5,269 kWh
Dutput	Proposed
•	
Detached dwelling	4,327 kWh

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3.3 External Lighting		100%			
Score Contribution	This credit contributes 5.0% towards the category	ory score.			
Criteria	Is the external lighting controlled by a motion de	etector?			
Question	Criteria Achieved ?				
Detached dwelling	Yes				
3.4 Clothes Drying		100%			
Score Contribution	This credit contributes 5.0% towards the category	ory score.			
Criteria	What is the % reduction in annual energy consu	What is the % reduction in annual energy consumption (gas and electricity) from a			
	combination of clothes lines and efficient driers	against the benchmar	rk?		
Output	Reference				
Detached dwelling	705 kWh				
Output	Proposed				
Detached dwelling	141 kWh				
Output	Improvement				
Detached dwelling	80 %				
3.5 Internal Lighting - Residenti	al Single Dwelling	100%			
Score Contribution	This credit contributes 5.0% towards the category	ory score.			
Criteria	Does the development achieve a maximum illun less?	nination power density	of 4W/	sqm or	
Question	Criteria Achieved?				
Detached dwelling	Yes				
4.4 Renewable Energy Systems	- Other	N/A	0	Disabled	
This credit is disabled	No other (non-solar PV) renewable energy is in u	ise.			
4.5 Solar PV - Houses and Towr	houses	N/A	0	Disabled	
This credit is disabled	No solar PV renewable energy is in use.				

Stormwater Overall contribution 14% Minimum required 100%

Which stormwater modelling are yo	u using?: Melbourne Water STORM tool
1.1 Stormwater Treatment	100%
Score Contribution	This credit contributes 100.0% towards the category score.
Criteria	Has best practice stormwater management been demonstrated?
Question	STORM score achieved
Project	100
Output	Min STORM Score
Project	100

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IEQ Overall contribution 13% Minimum required 50%

2.2 Cross Flow Ventilation	100%			
Score Contribution	This credit contributes 20.0% towards the category score.			
Criteria	Are all habitable rooms designed to achieve natural cross flow ventilation?			
Question	Criteria Achieved ? Yes			
Detached dwelling				
3.1 Thermal comfort - Double Glazing	100%			
Score Contribution	This credit contributes 40.0% towards the category score.			
Criteria	Is double glazing (or better) used to all habitable areas?			
Question	Criteria Achieved ?			
Detached dwelling	Yes			
3.2 Thermal Comfort - External Shadir	100%			
Score Contribution	This credit contributes 20.0% towards the category score.			
Criteria	Is appropriate external shading provided to east, west and north facing glazing?			
Question	Criteria Achieved ?			
Detached dwelling	Yes			
3.3 Thermal Comfort - Orientation	0%			
Score Contribution	This credit contributes 20.0% towards the category score.			
Score Contribution Criteria	This credit contributes 20.0% towards the category score. Are at least 50% of living areas orientated to the north?			

Transport Overall contribution 0%

1.1 Bicycle Parking - Residential	0%		
Score Contribution	This credit contributes 50.0% towards the category score.		
Criteria	How many secure and undercover bicycle spaces are there per dwelling for residents?		
Question	Bicycle Spaces Provided ?		
Detached dwelling	0		
2.1 Electric Vehicle Infrastructure	0%		
Score Contribution	This credit contributes 50.0% towards the category score.		
Criteria	Are facilities provided for the charging of electric vehicles?		
Question	Criteria Achieved ?		
Project	No		

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Waste Overall contribution 3%

1.1 - Construction Waste - Bu	uilding Re-Use	Re-Use 0%			
Score Contribution	This credit contributes 50.0% towards to	This credit contributes 50.0% towards the category score.			
Criteria	If the development is on a site that has the existing building been re-used?	If the development is on a site that has been previously developed, has at least 30% of the existing building been re-used?			
Annotation	Sub division of exciting building, no exis	sting buildings on proposed site			
Question	Criteria Achieved ?	Criteria Achieved ?			
Project	-				
2.1 - Operational Waste - Foo	d & Garden Waste	100%			
Score Contribution	This credit contributes 50.0% towards to	he category score.			
Criteria	Are facilities provided for on-site manag	ement of food and garden waste?			
Annotation	FOGO service provided by council				
Question	Question Criteria Achieved ?				
Project	Yes				

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Urban Ecology Overall contribution 3%

2.1 Vegetation	75%
Score Contribution	This credit contributes 57.1% towards the category score.
Criteria	How much of the site is covered with vegetation, expressed as a percentage of the
	total site area?
Question	Percentage Achieved ?
Project	24 %
2.2 Green Roofs	0%
Score Contribution	This credit contributes 14.3% towards the category score.
Criteria	Does the development incorporate a green roof?
Question	Criteria Achieved ?
Project	No
2.3 Green Walls and Facades	0%
Score Contribution	This credit contributes 14.3% towards the category score.
Criteria	Does the development incorporate a green wall or green façade?
Question	Criteria Achieved ?
Project	No
3.1 Food Production - Residential	100%
Score Contribution	This credit contributes 14.3% towards the category score.
Criteria	What area of space per resident is dedicated to food production?
Question	Food Production Area
Detached dwelling	1.0 m ²
Output	Min Food Production Area
Detached dwelling	1 m²

Innovation Overall contribution 0%

1.1 Innovation	0% This credit contributes 100.0% towards the category score.	
Score Contribution		
Criteria	What percentage of the Innovation points have been claimed (10 points maximum)?	


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REVISION DATE

PROJECT: PROPOSED SECOND DWELLING CLIENT: ALI ALKHAFAJI

ADDRESS: 12 BALCOMBE COURT CRAIGIEBURN

DRAWING TITLE: PROPOSED SITE PLAN

SCALE: 1:250 @ A3 DRAWN BY: Ron Popelier

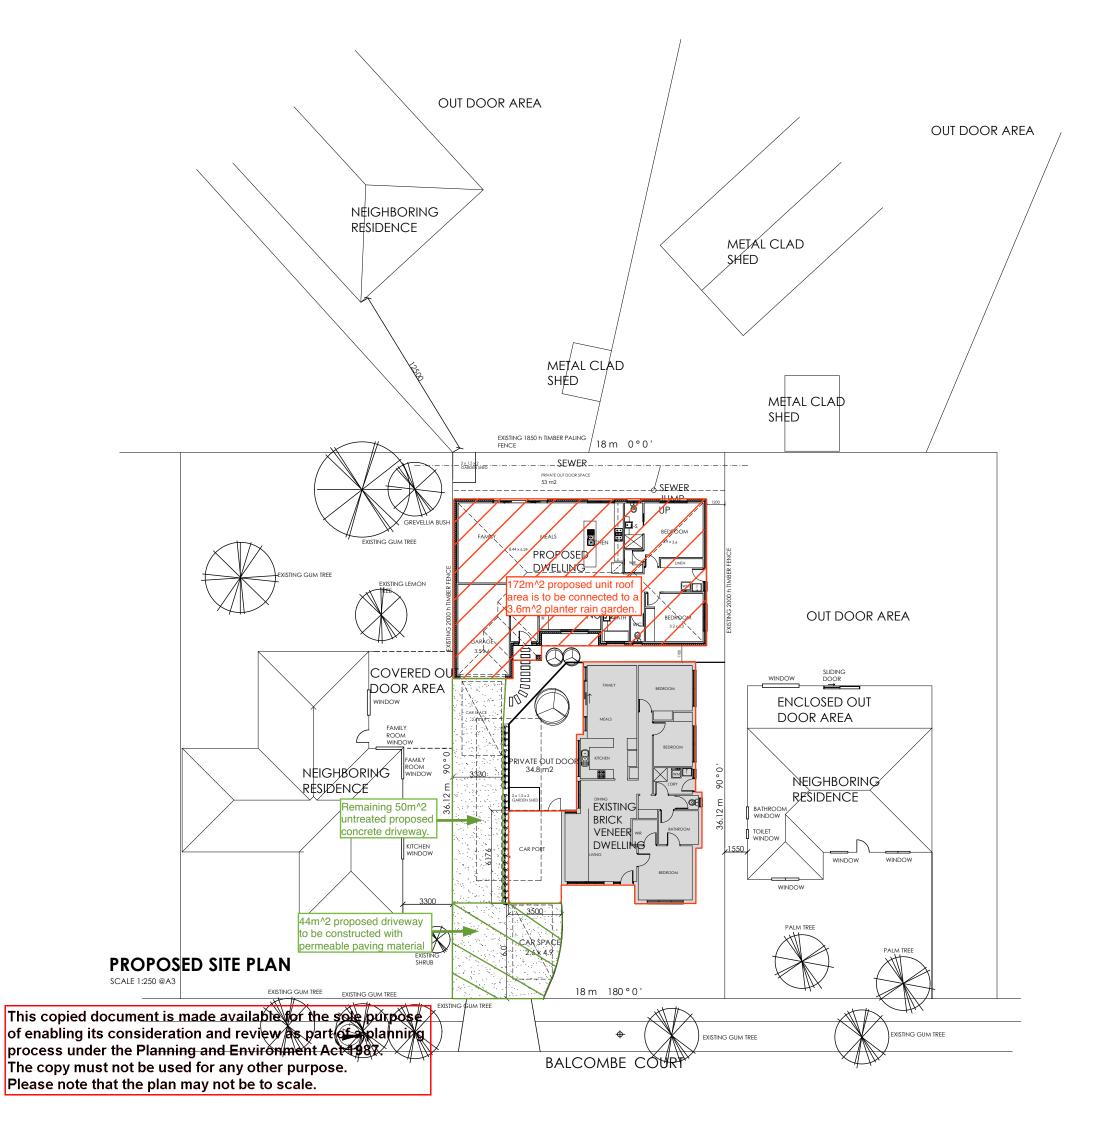lier 26.10.2021

PROJECT NO: 3903 20 SHEET NO:

DRAWING NO: REVISION

122 HIGH STREET
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Melbourne STORM Rating Report

TransactionID: 1258423 **HUME** Municipality: Rainfall Station: **HUME**

Address: 12 Balcombe Court

Craigieburn

VIC

Nadir Yonan Assessor:

Development Type: Residential - Multiunit

Allotment Site (m2): 360.00 STORM Rating %: 100

Description	Impervious Area (m2)	Treatment Type	Treatment Area/Volume (m2 or L)	Occupants / Number Of Bedrooms	Treatment %	Tank Water Supply Reliability (%)
Proposed Unit	172.00	Raingarden 100mm	3.60	0	128.50	0.00
Driveway	50.00	None	0.00	0	0.00	0.00

Program Version:

CLIENT: ALI ALKHAFAJI

PROJECT: PROPOSED SECOND RESIDENCE

DATE ISSUE: 6.11.2021

JOB NO: 3903.20

DRAWING SCHEDULE

001 EXISTING SITE PLAN 002 PROPOSED SITE PLAN 003 EXISTING FLOOR PLAN 004 PROPOSED FLOOR PLAN 005 EXISTING ELEVATIONS 006 PROPOSED ELEVATIONS

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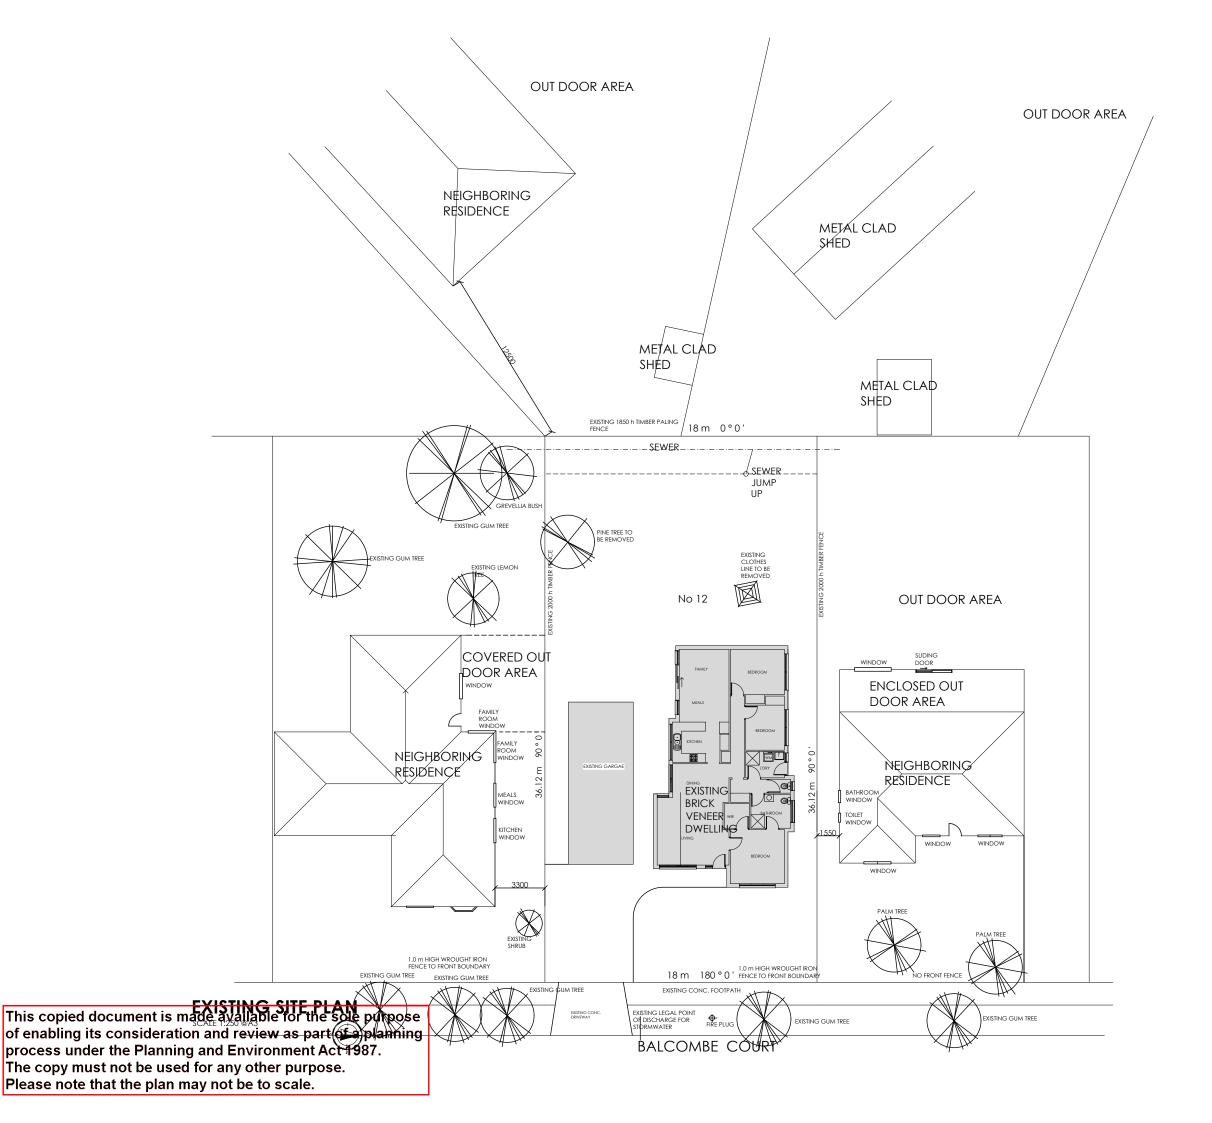
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REVISION DATE

PROJECT: PROPOSED SECOND DWELLING CLIENT: ALI ALKHAFAJI

ADDRESS: 12 BALCOMBE COURT CRAIGIEBURN

DRAWING TITLE:
EXISTING SITE PLAN


SCALE: 1:250 @ A3 DRAWN BY: Ron Popelier ISSUE DATE: 6.11.2021

PROJECT NO: 3903.20 NO:

NO: REVISION NO

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UNIT 1 LAND AREA 311 m2 CARPORT UNIT SIZE 146 m2 PRIVATE OUTDOOR AREA 34.8 M2

UNIT 2 LAND AREA 339.16 m2 CARPORT UNIT SIZE 167 m2 PRIVATE OUTDOOR AREA 53 M2

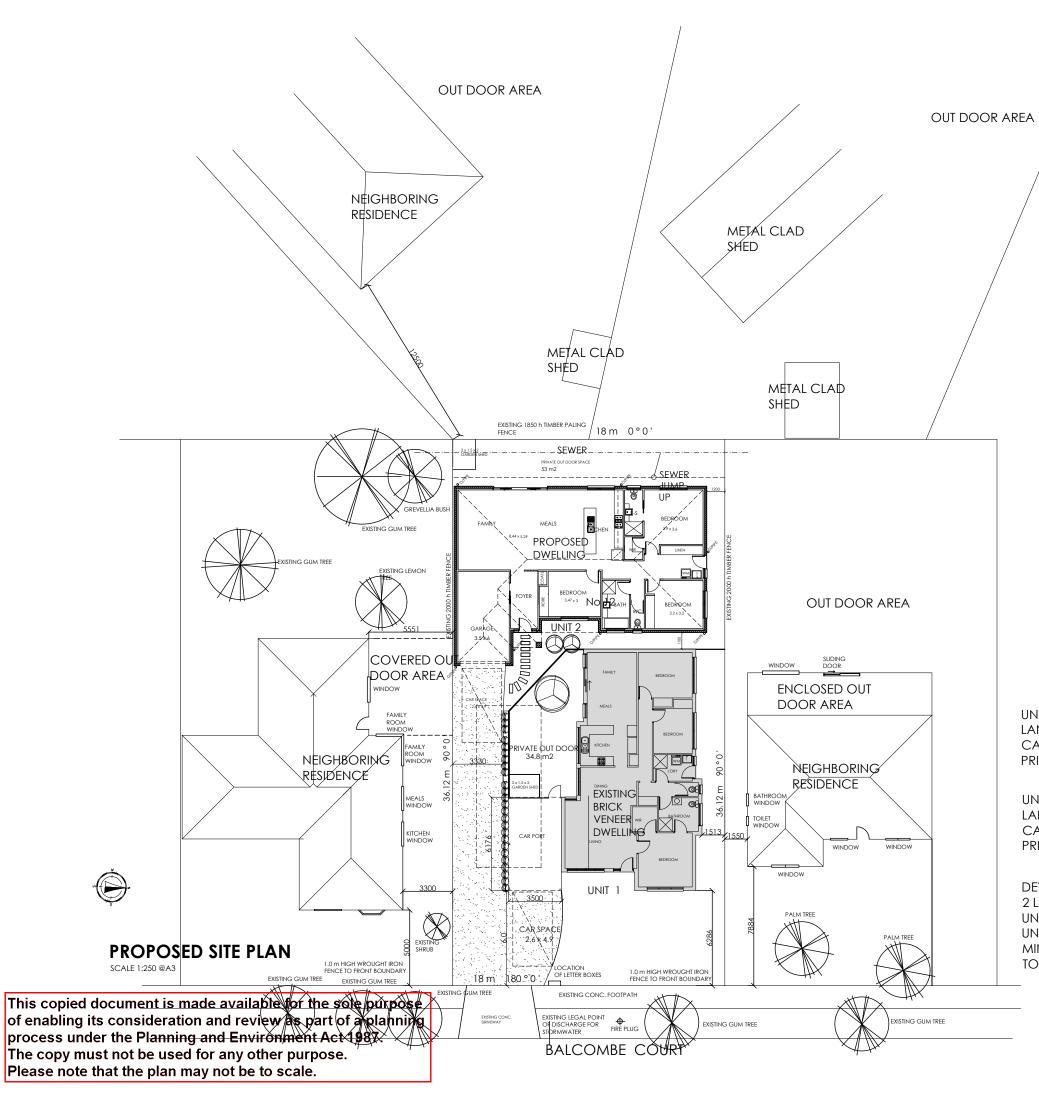DEVELOPMENT TO BE SUBDIVIDED INTO 2 LOTS UNIT 1 BLOCK AREA 311 m2 UNIT 2 BLOCK AREA 339.16 MINIMUM GARDEN AREA NOT APPLICABLE TO THIS DEVELOPMENT

PROJECT: PROPOSED SECOND DWELLING CLIENT: ALI ALKHAFAJI

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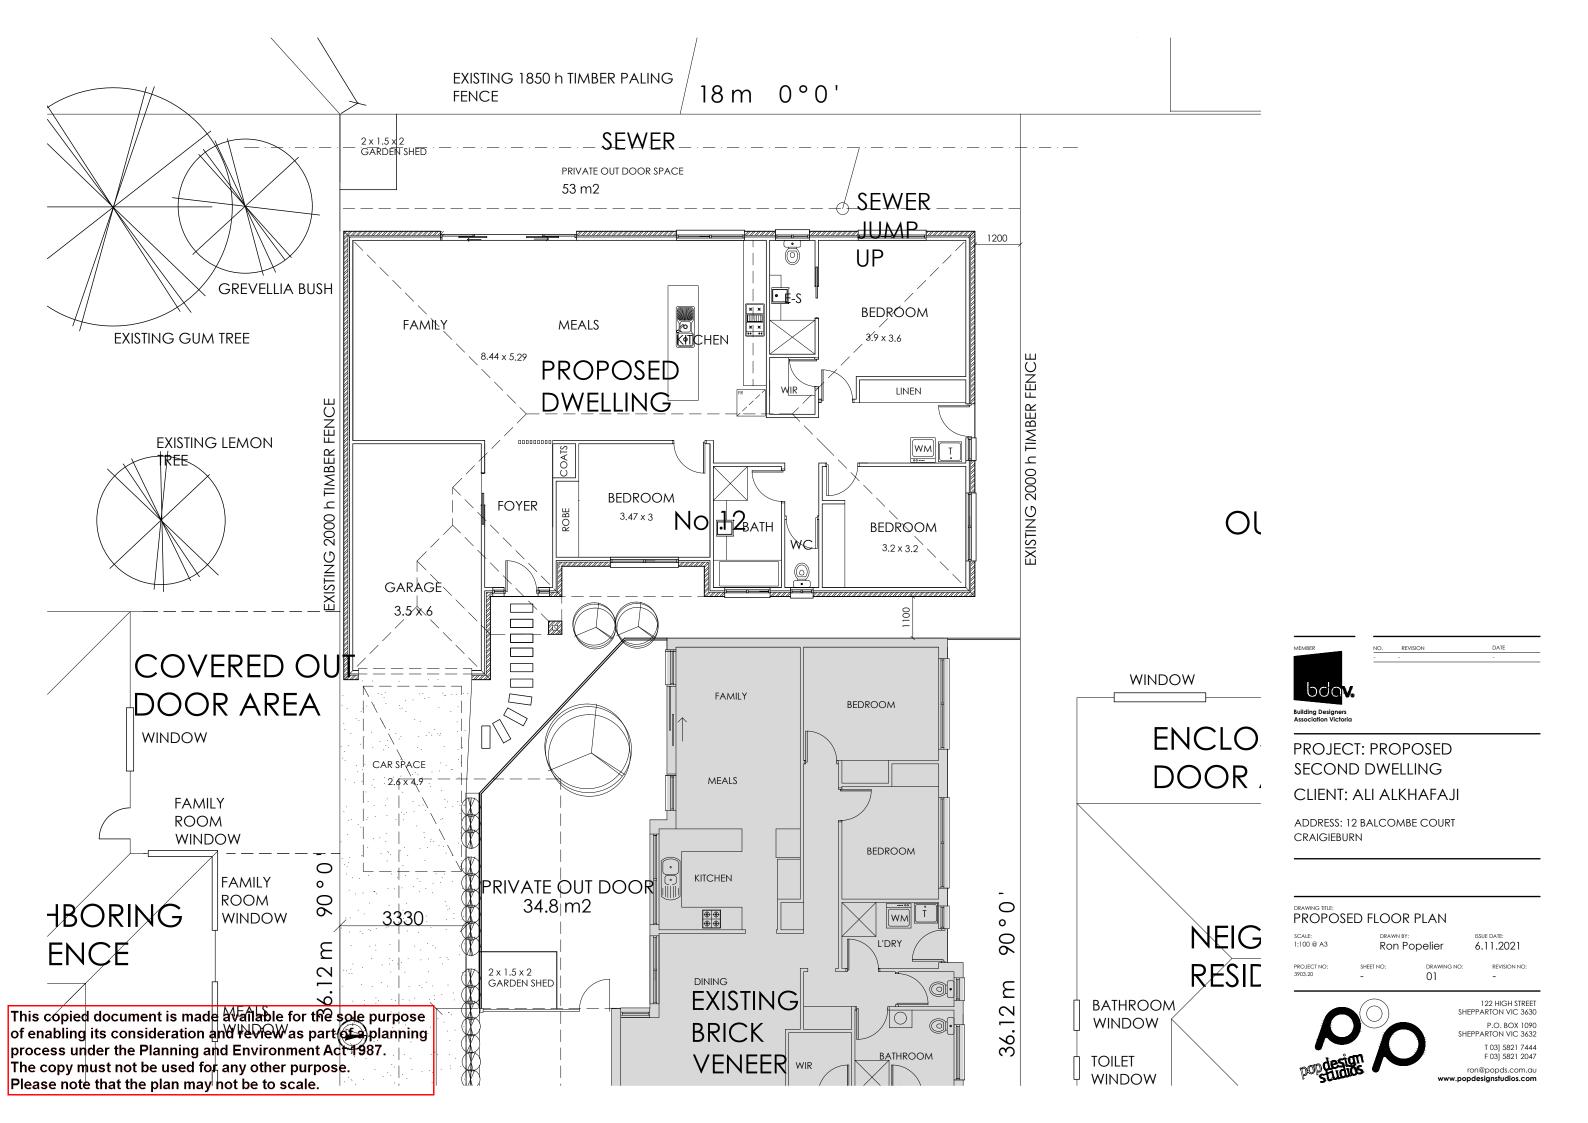
PROPOSED SITE PLAN


Ron Popelier


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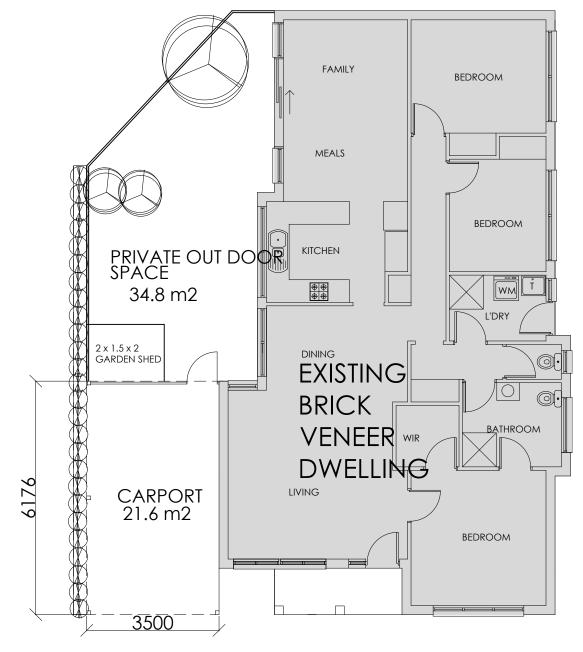
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EAST ELEVATION EXISTING RESIDENCE



FLOOR PLAN EXISTING RESIDENCE

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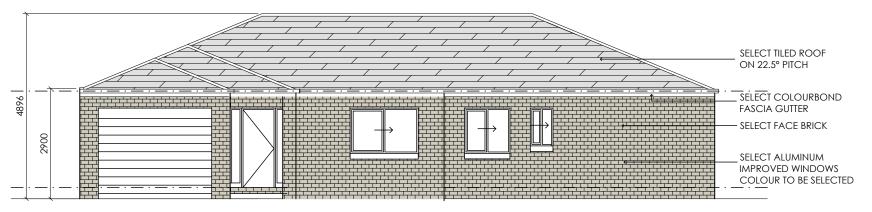
PROPOSED FLOOR PLAN

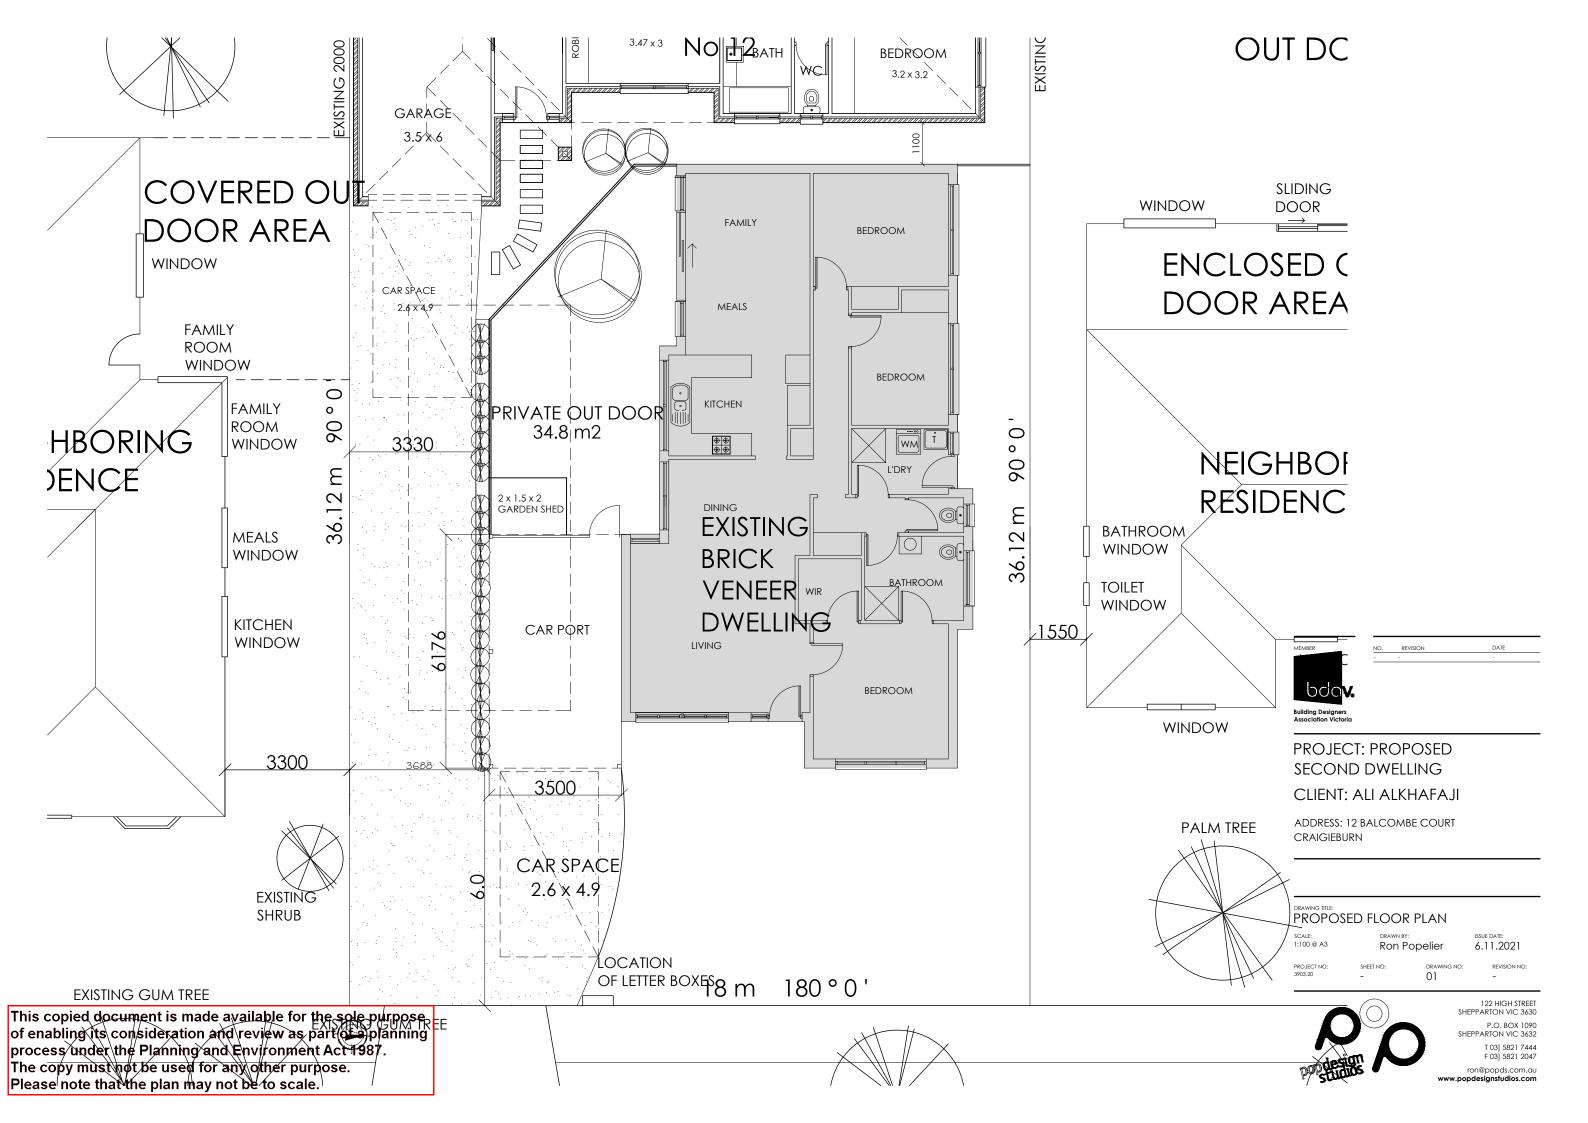Ron Popelier

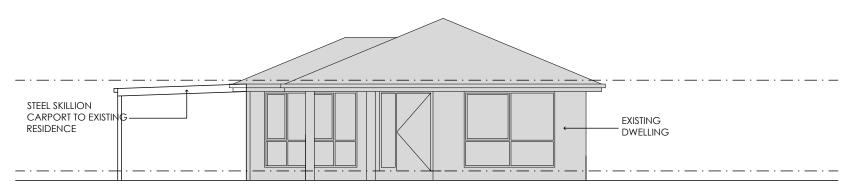
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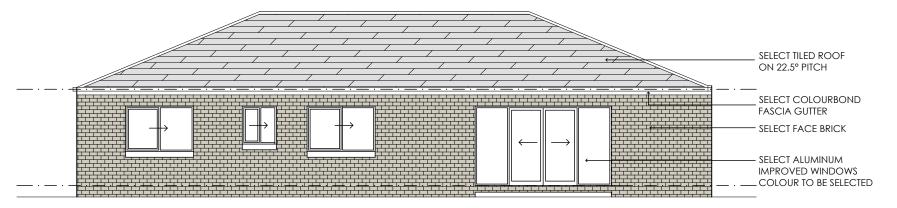
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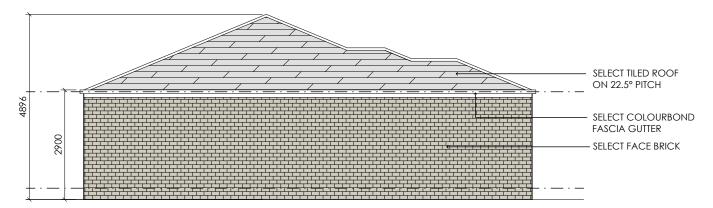
EAST ELEVATION



NORTH ELEVATION



WEST ELEVATION

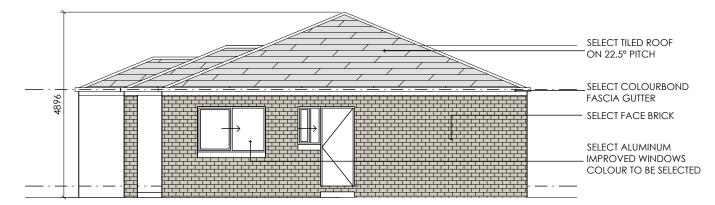

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PROJECT: PROPOSED SECOND DWELLING CLIENT: ALI ALKHAFAJI

ADDRESS: 12 BALCOMBE COURT CRAIGIEBURN

DRAWING TITLE:
PROPOSED FLOOR PLAN

Ron Popelier

6.11.2021



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PROJECT: PROPOSED SECOND DWELLING CLIENT: ALI ALKHAFAJI

ADDRESS: 12 BALCOMBE COURT CRAIGIEBURN

DRAWING TITLE:
PROPOSED NEIGHBORHOOD **ELEVATION**

Ron Popelier

DRAW 01

1:250 @ A3

6.11.2021

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INSTRUCTION SHEET

Building a planter box raingarden (lined)

healthy waterways Raingardens

What is a planter box raingarden?

Building a raingarden is a simple way to help the environment and the health of our local waterways while providing a self-watering garden for your backyard.


A raingarden is a specially prepared garden designed to receive and filter rain run-off from roofs or hard surfaces such as driveways or paving. You can even create a raingarden in a planter box, positioning it to collect water from a diverted downpipe or rainwater tank overflow.

Featuring layers of soil for filtration, gravel for drainage, and plants that can tolerate periods without rain, a raingarden helps to protect our streams and rivers from stormwater pollutants.

With a slotted pipe beneath the soil to take away the filtered rainwater and an overflow pipe on the surface to prevent flooding, raingardens are designed to collect water from a diverted downpipe, rainwater tank overflow or pavement runoff.

Please note: A certified plumber must be used for stormwater connections and modifications.

Did you know that a raingarden is only wet during and immediately after rain, leaving it dry most of the time? This is due to the drainage and filtration properties of the soil combination used in the raingarden.

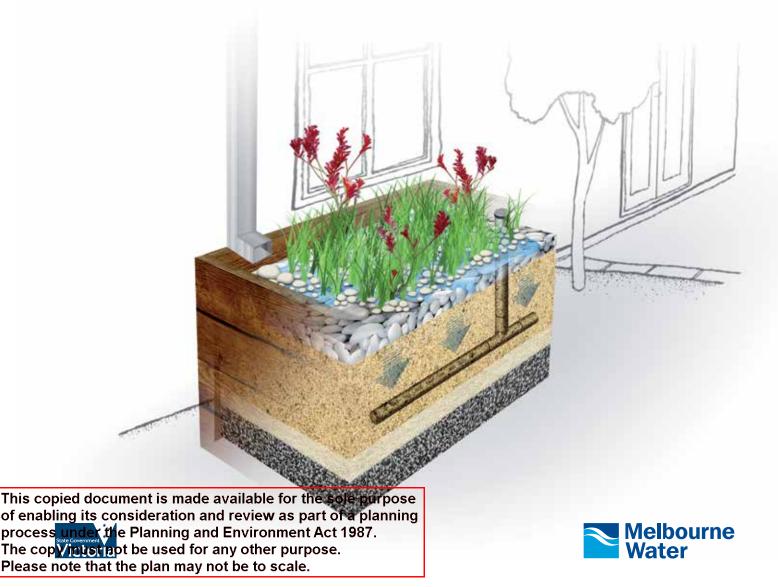

Step 1 – getting started

Location

Build your planter box as close as possible to the water source whether it be a downpipe or rainwater tank overflow. This will help minimise the additional plumbing needed to bring water to the raingarden. Your raingarden needs to sit at least 300mm away from your house.

Having decided on a location, it is important to determine the proximity of the existing stormwater pipe to make sure your raingarden is connected properly. Your local plumber can help with this and also how and when to divert your downpipe so that the area doesn't flood during construction.

Stormwater reconnection

All connections or modifications to existing stormwater pipes need to be done by a licensed plumber. The plumber should ensure that pipes are reconnected into the property's stormwater and not another services such as the sewer.

Underground services

Be aware of any underground services (gas, electricity, water) that run near your house as this may determine where you can build your raingarden. Raingardens should not be built over or in close proximity to a septic system.

Materials


See *Materials List* for information about what you need to build a raingarden.

Size

You need to make sure that your raingarden is large enough to manage the amount of stormwater it will receive. If your raingarden is going to capture run-off from the roof via a downpipe, measure the area of roof that drains to that downpipe. Generally, the size of the raingarden should be approximately 2% of the run-off area. Table 1 will help you work out the correct size.

Table 1 - Raingarden sizing chart

AREA OF RUN-OFF (m²)	RAINGARDEN SIZE (m²)
50	1
100	2
150	3
200	4
250	5
300	6
350	7
400	8
450	9

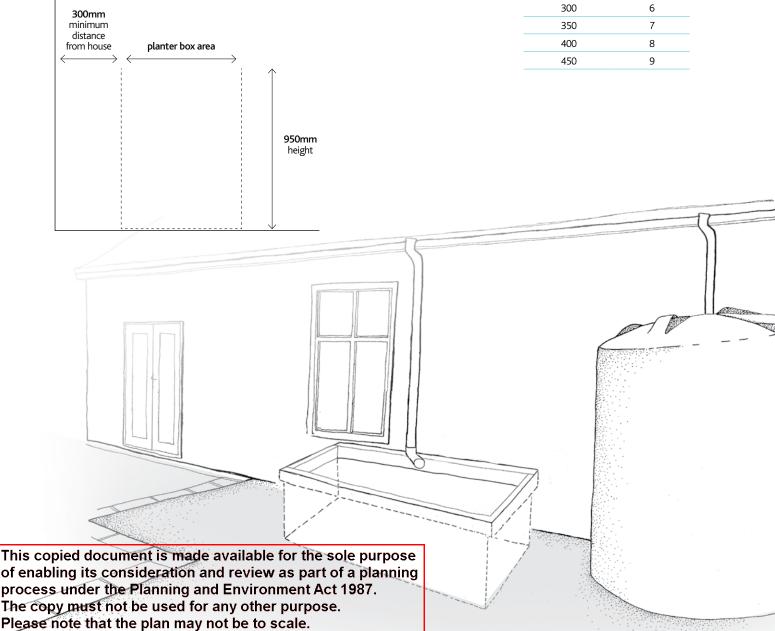

Step 2 - planter box and pipe infrastructure

Preparing your planter box

You can create a planter box out of any material as long as it is strong enough to hold soil. This could be a corrugated iron 'tank', an old wine barrel, or you could build your own planter box using plantation hardwood or similar.

Line your planter box (sides and base) with a PVC liner. Overlap the sheets by 200mm and seal the joins with PVC tape.

Place the 7mm screenings (gravel) to a depth of 50mm. This will form a base for the slotted drainage pipe. Make sure the screenings are washed and cleaned of excess dirt as this can create blockages in the raingardens drainage.

Use the screenings to create a gentle slope towards the stormwater outlet (where the water will exit your planter box).


Pipe infrastructure

Lay a 90mm diametre slotted drainage pipe horizontally along the centre of the planter box base and cap one end of the slotted drainage pipe. Call your plumber to connect the drainage pipe back into the property's existing stormwater.

Handy Hint — If your raingarden is greater than 4m wide, you will need to install two slotted drainage pipes and two overflow pipes. These need to be evenly spaced across the planter box base to provide adequate drainage.

Connect the vertical 90mm diameter overflow pipe into the slotted drainage pipe using a 90 degree elbow pipe. When the raingarden is finished, the top of the overflow pipe should sit 100mm above the gravel mulch and 100mm below the top edge of the planter box.

Install a temporary cap on top of the overflow pipe to prevent materials dropping into it during construction. Some plastic taped across the top of the pipe will work fine.

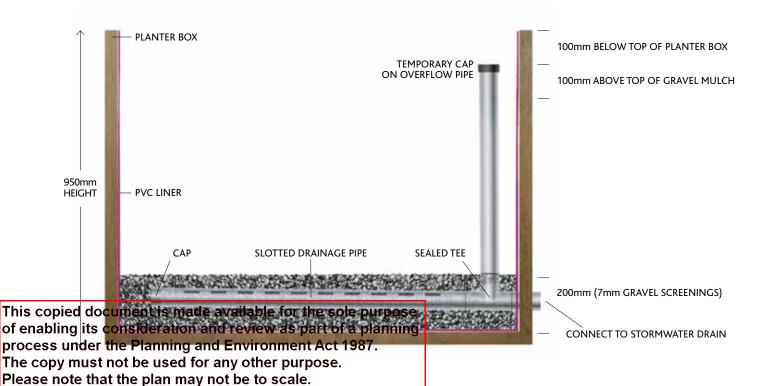

Step 3 - soil layers

Screenings layer

Add 7mm screenings (gravel) to a depth of 150mm over the slotted drainage pipe in the base of your raingarden. This brings to total depth of screenings (gravel) to 200mm. Be careful when not to dislodge or damage the slotted drainage pipe when adding the additional screenings.

Sand layer

Place white washed sand to a depth of 100mm over the screenings (gravel) layer.

Sand/soil mix layer

Mix 4 parts white washed sand with 1 part topsoil. Add this mix to the raingarden to a depth of 400mm.

Handy Hint - Ensure you firmly pat down each layer of soil when building your raingarden to help reduce the layers from sinking.

Please note that the plan may not be to scale.

Step 4 -pipe adjustments, plants and mulch

Pipe adjustments

Redirect your downpipe into the raingarden using pipe bends where required. If possible, use two 45 degree bends connected together as this will provide a much gentler and more even flow of water, reducing the risk of erosion and prevent blockages within the downpipe. A 90 degree elbow pipe will do as an alternative.

Plants

In general, plants that grow well in a raingarden:


- like dry conditions but can tolerate temporary wet periods
- > are perennial rather than annual
- > have an extensive fibrous root system.

A wide range of plants are suitable for raingardens and your local nursery will be able to guide you on what is right for your area. There are also particular plants that are really good at removing pollutants from stormwater. These include:

- > Carex appressa
- > Lomandra longifolia
- > Juncus flavidus
- > Melaleuca ericifolia
- > Goodenia ovate.

50% of your raingarden should be planted with these species, the other 50% can be made up of plants that like a dry environment with intermittent wet periods. It is important that the plants you select are suitable for the amount of sun and shade on your raingarden. See the *Plant List* for a suggested list of suitable raingarden plants.

Regardless of the type of plants you select, it is important to plant densely to cover the raingarden. Set your plants out at roughly 6 plants per m². So for a 2m² raingarden, you will need to buy 12 plants. Now start planting. (continued on next page)

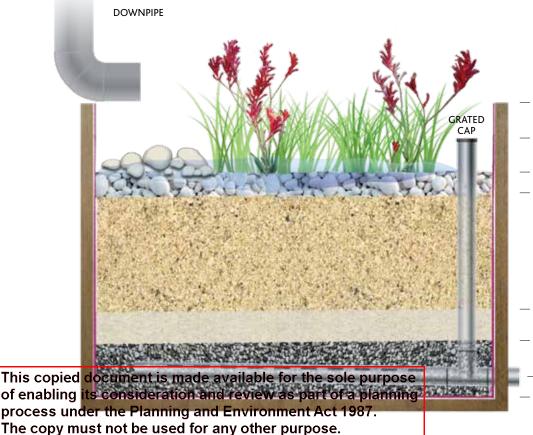

100mm BELOW TOP OF PLANTER BOX

100mm ABOVE TOP OF GRAVEL MULCH

50mm GRAVEL MULCH

400mm SAND/SOIL MIX

100mm SAND

200mm (7mm GRAVEL SCREENINGS)

CONNECT TO STORMWATER DRAIN

Looking after your raingarden

Mulch

To allow the spread of water gently over the raingarden, place some large flat rocks where water flows from the downpipe. Place smaller rocks in between the large rocks to fill the gaps and help prevent erosion. Alternatively a flow spreading device can be fitted to the downpipe.

Spread gravel mulch to a depth of 50mm around the plants.

Remove the temporary end cap from overflow pipe and replace with a 90mm PVC finishing collar and domed pipe grate.

Water the plants in – complying with your local water restrictions.

Once established, raingardens are low maintenance especially when planted with native plant species. They don't need to be watered, mowed or fertilised. However, a few simple tips can help your raingarden mature and function well.


- Gravel mulch will help retain moisture in your raingarden and prevent weeds from growing.
- Ensure that the overflow is never blocked.
- Remove any sediment or build up from the downpipe.
- Some weeding may need to take place until plants have matured.
- Evenly distribute water flow into your garden to limit erosion from heavy rainfall. Strategically placed rocks may help with this.

 Inspect your garden regularly – replace plants and repair erosion when necessary.

Note – If necessary, water your raingarden until your plants have established in compliance with your local water restrictions.

Need help?

If you have questions about building a raingarden, your landscape gardener or local plumber may be able to help. For more information visit melbournewater.com.au/raingardens

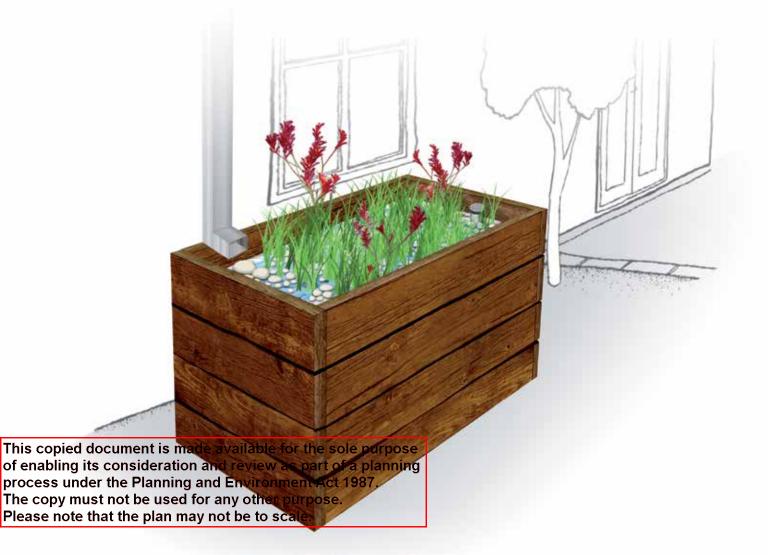

Materials List – what you need to build your raingarden

Table 2 details the materials required to create a 2m² raingarden. While item prices may vary depending on the materials you select, building a 2m² raingarden is likely to cost between \$400 and \$500 (plus the cost of a planter box and plumber).

QUANTITY	MATERIAL
2 l/m	90mm diameter slotted drainage pipe (Ag Pipe)
2 l/m	90mm diameter uPVC pipe*
0.4m³	7mm screenings
0.85m³	Sand (white washed)
0.15m³	Topsoil
12	Plants (150mm pots)
0.1m³	Gravel mulch
1	90mm diameter uPVC 90 degree bend or 2x 45 degree bends
1	PVC grate 90mm finishing collar
1	PVC 90mm diameter domed pipe grate
1	PVC 90mm tee
1	PVC 90mm cap
10m²	PVC liner
	PVC tape

^{*}Costs per square meter will depend on the length of connections back to the existing stormwater drain.

 $l/m = lineal\ metres \quad m^2 = square\ metres \quad m^3 = cubic\ metres \quad mm = millimetres$





Plant List – the best plants for your raingarden

The following plants grow well in raingardens.

BOTANICAL NAME	COMMON NAME	CONDITIONS	SIZE (H x W) (cm)	
Anigozanthos sp.	Kangaroo paw	Full sun	30-90 x 100-120	
Blechnum nudum	Fishbone Water-fern	Full sun to partial shade	50-100 x 40-80	
Calocephalus lacteus	Milky Beauty-heads	Full sun to partial shade	15-30 x 10-30	
Carex Appressa	Tall Sedge	Full sun to partial shade	80-100 x 120	
Carpobrotus modestus	Pigface	Full sun	20cm high and spreading	
Chrysocephalum apiculatum	Common Everlasting	Full sun	30-90 x 10-30	
Derwentia perfoliata	Digger's Speedwell	Full sun to partial shade	20-40 x 30-60	
Dianella species		Full sun to partial shade	60-120 x 40-150	
Ficinia nodosa	Knobby Club-rush	Full sun	50-150 x 60-200	
Juncas amabilis	Hollow Rush	Full sun to partial shade	20-120 x 20-50	
Juncas flavidus	Yellow Rush	Full sun to partial shade	40-120 x 20-100	
Leucaphyta brownii	Cushion Bush	Full sun, salt tolerant	100 x 200	
Lomandra species		Full sun to partial shade	60-120 x 50-100	
Melaleuca ericifolia	Swamp paperback	Full sun to partial shade	4m high x 3m wide	
Myoporum parvifolium	Creeping Boobialla	Full sun	20-30 x 300	
Patersonia occidentalis	Native iris	Sun to partial shade	20-40 x 30-60	
Pratia perdunculata	Matter Pratia	Partial shade	50-150 x 1.8-5	
Wahlenbergia communis	Tufted Bluebell	Full sun	15-50 x 15	



Melbourne Water 990 La Trobe Street Docklands VIC 3008 PO Box 4342

PO Box 4342 Melbourne Victoria 3001

Telephone 131 722 melbournewater.com.au/raingardens


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PROJECT: PROPOSED SECOND DWELLING CLIENT: ALI ALKHAFAJI

ADDRESS: 12 BALCOMBE COURT CRAIGIEBURN

DRAWING TITLE:
EXISTING SITE PLAN

SCALE: 1:250 @ A3

Ron Popelier

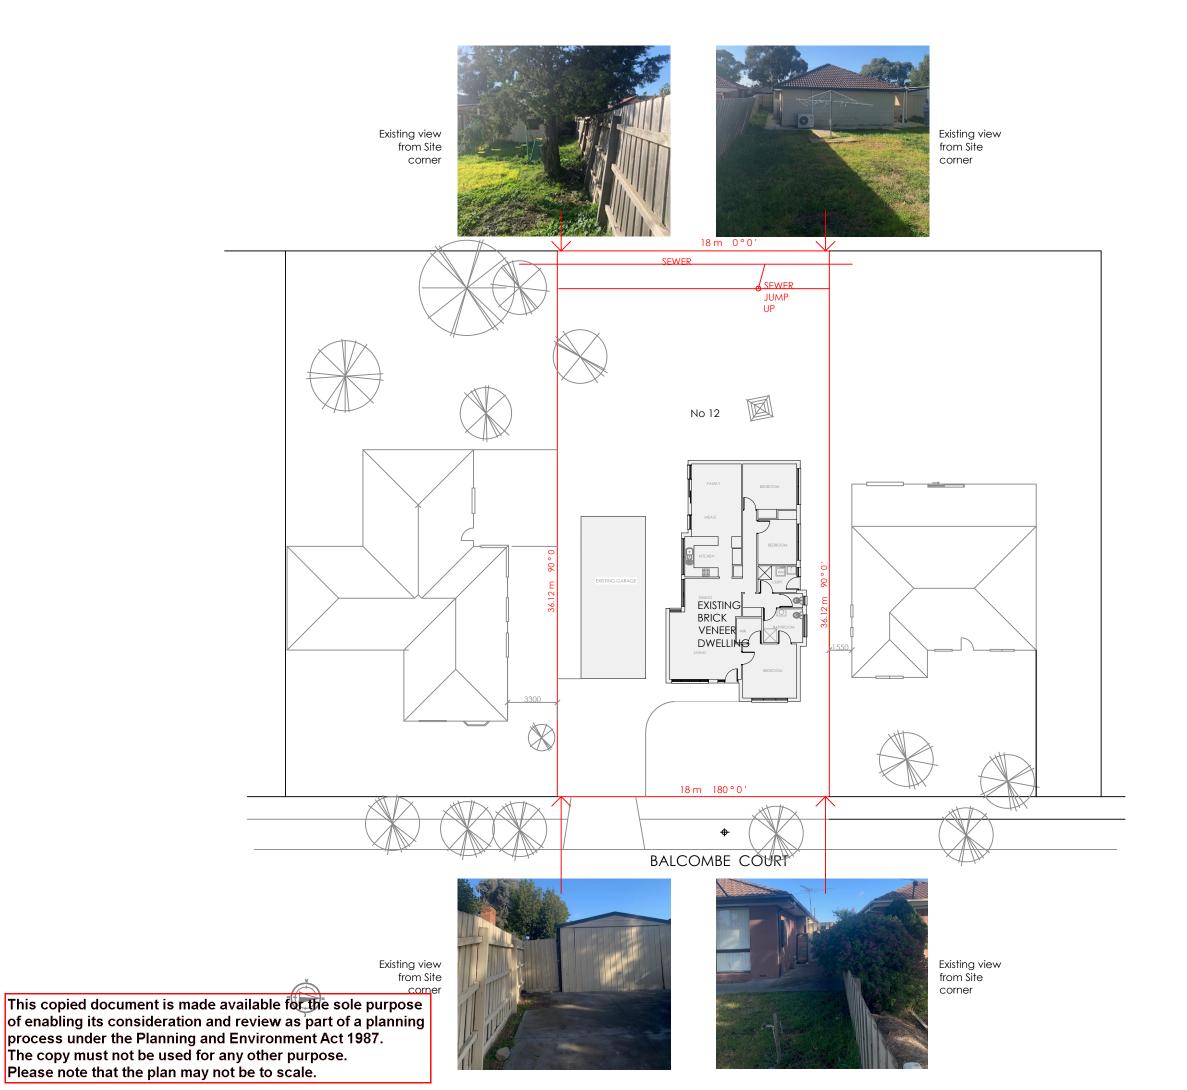
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145 THE BOULEVARD SHEPPARTON VIC 3630

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LOCALITY: CRAIGIEBURN VIC



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ADDRESS: 12 BALCOMBE COURT CRAIGIEBURN

LOCALITY
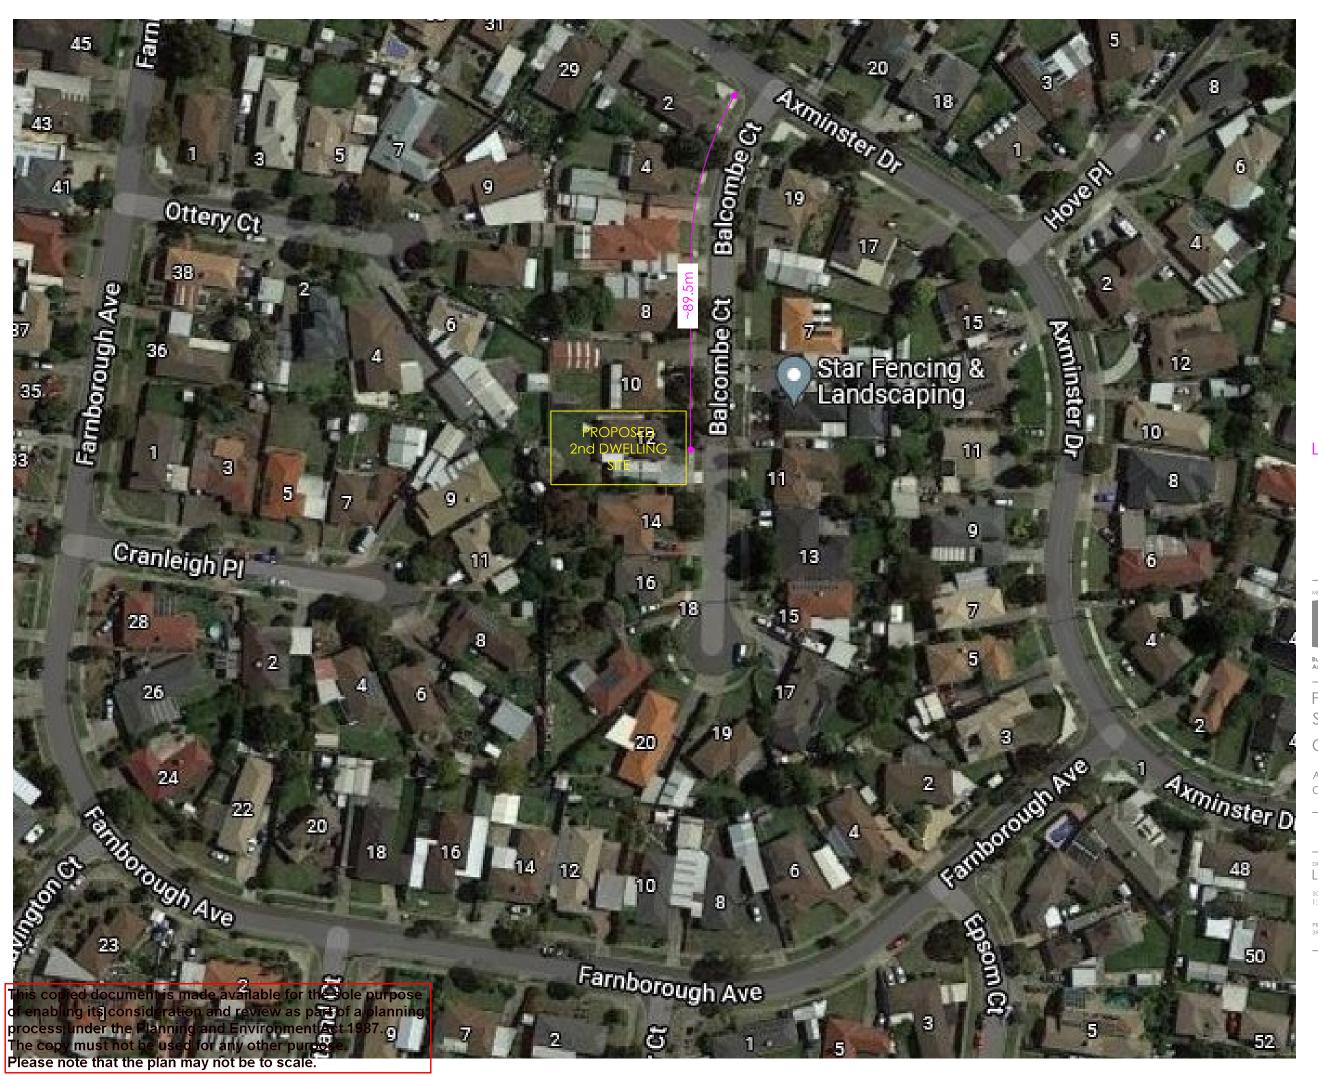
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Ron Popelier

04.11.2021

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CLIENT: ALI ALKHAFAJI

PROJECT: PROPOSED SECOND RESIDENCE

DATE ISSUE: 15.12.2021

JOB NO: 3903.20

DRAWING SCHEDULE

001 EXISTING SITE PLAN 002 PROPOSED SITE PLAN 003 EXISTING FLOOR PLAN 004 PROPOSED FLOOR PLAN 005 EXISTING ELEVATIONS 006 PROPOSED ELEVATIONS

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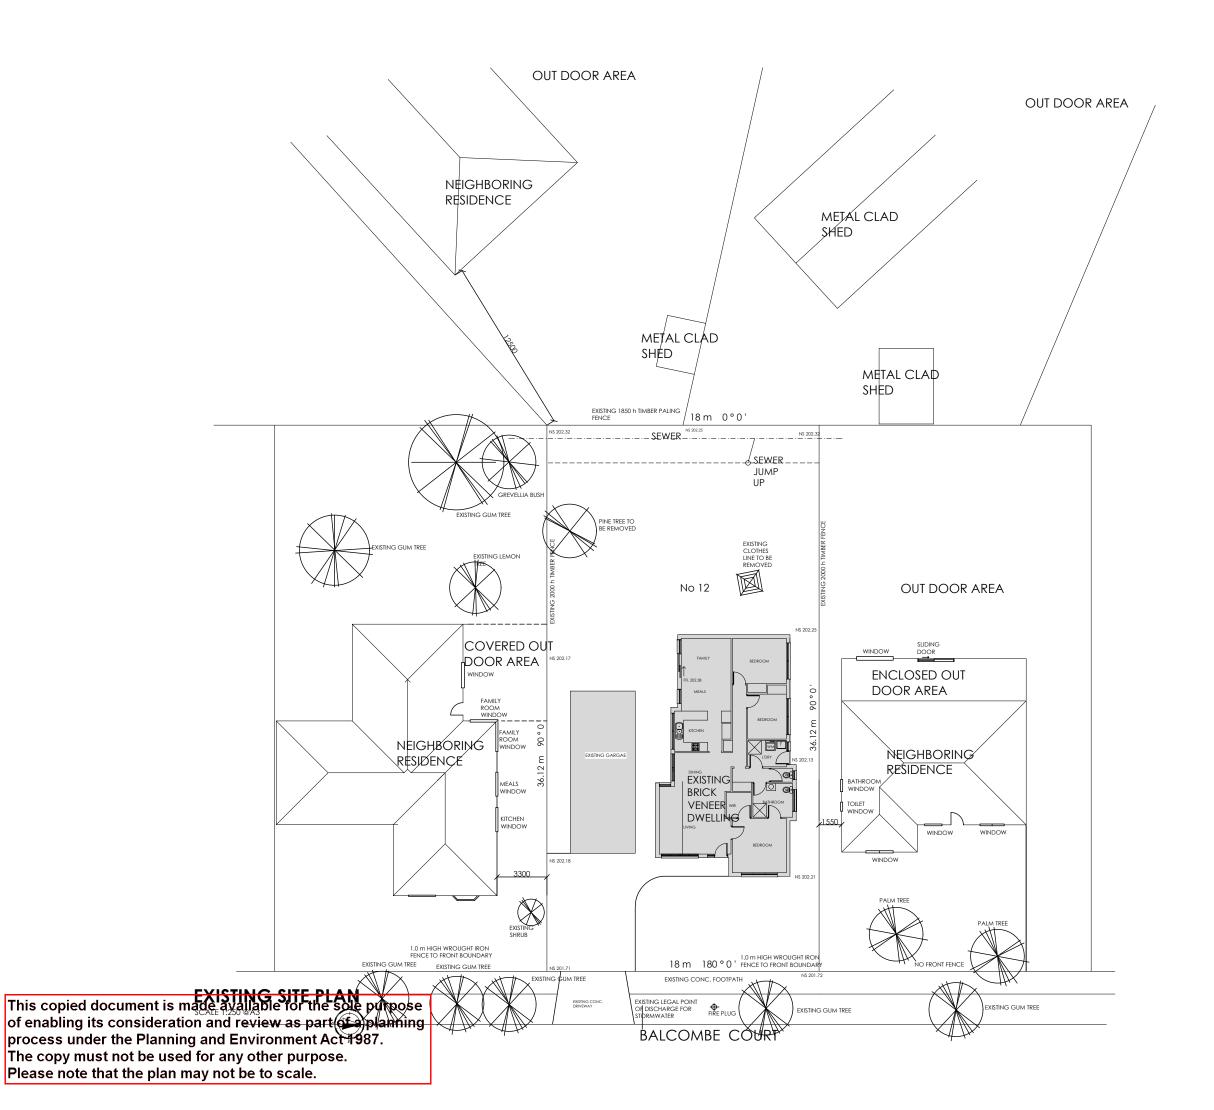
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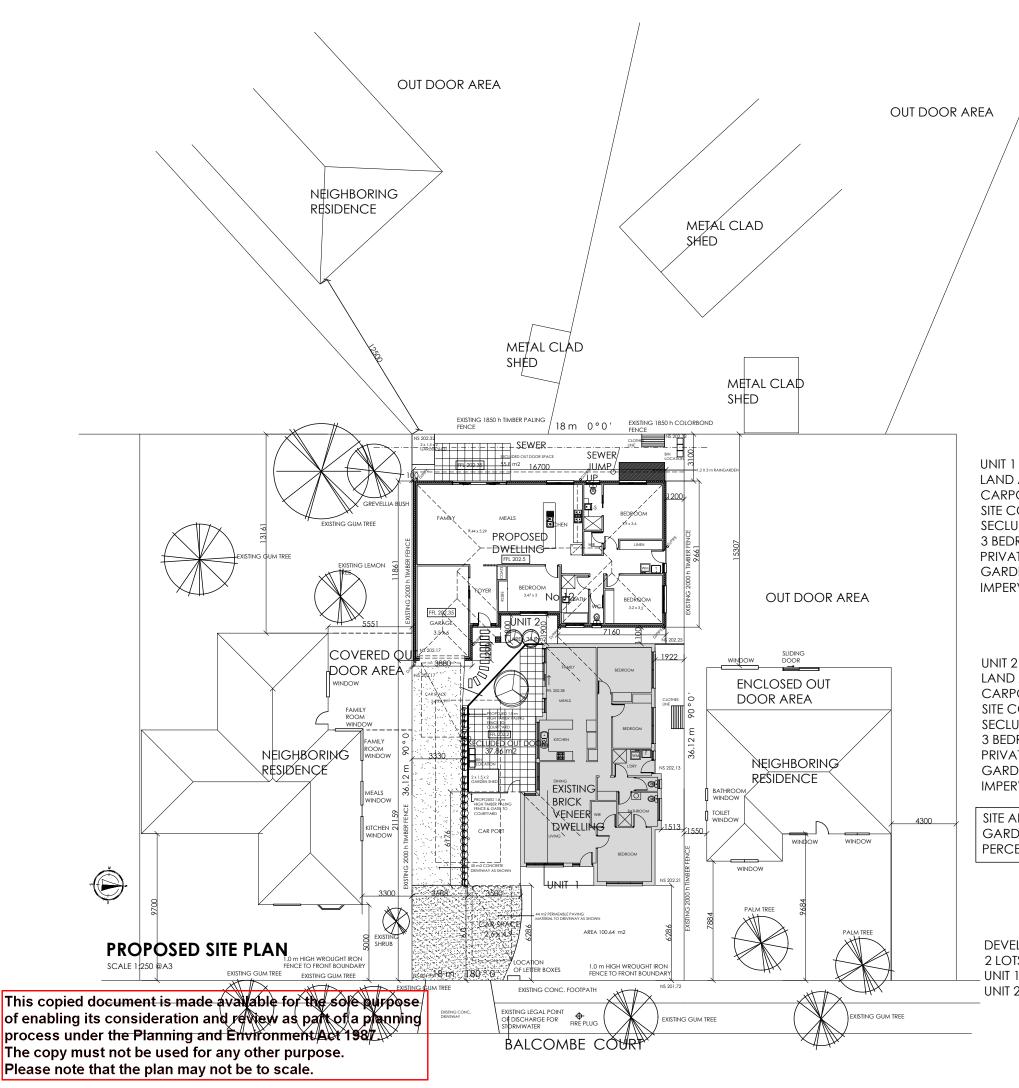
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LAND AREA 311 m2
CARPORT UNIT SIZE 146 m2
SITE COVERAGE 46.94 %
SECLUDED OUTDOOR AREA 37.86 M2
3 BEDROOMS
PRIVATE OPEN SPACE 101 m2
GARDEN AREA 138.50 m2
IMPERVIOUS AREA 171 m2 PERCENTAGE 54.98%

UNIT 2
LAND AREA 339.16 m2
CARPORT UNIT SIZE 167 m2
SITE COVERAGE 49.24%
SECLUDED OUTDOOR AREA 55.8 M2
3 BEDROOMS
PRIVATE OPEN SPACE 33.7 m2
GARDEN AREA 91.59 m2
IMPERVIOUS AREA 239 m2 PERCENTAGE 70.46%

SITE AREA 650.16 m 2 GARDEN AREA 230.09 m2 PERCENTAGE 35.39 %

DEVELOPMENT TO BE SUBDIVIDED INTO 2 LOTS

UNIT 1 BLOCK AREA 311 m2
UNIT 2 BLOCK AREA 339.16



REVISION

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ADDRESS: 12 BALCOMBE COURT CRAIGIEBURN

PROPOSED SITE PLAN

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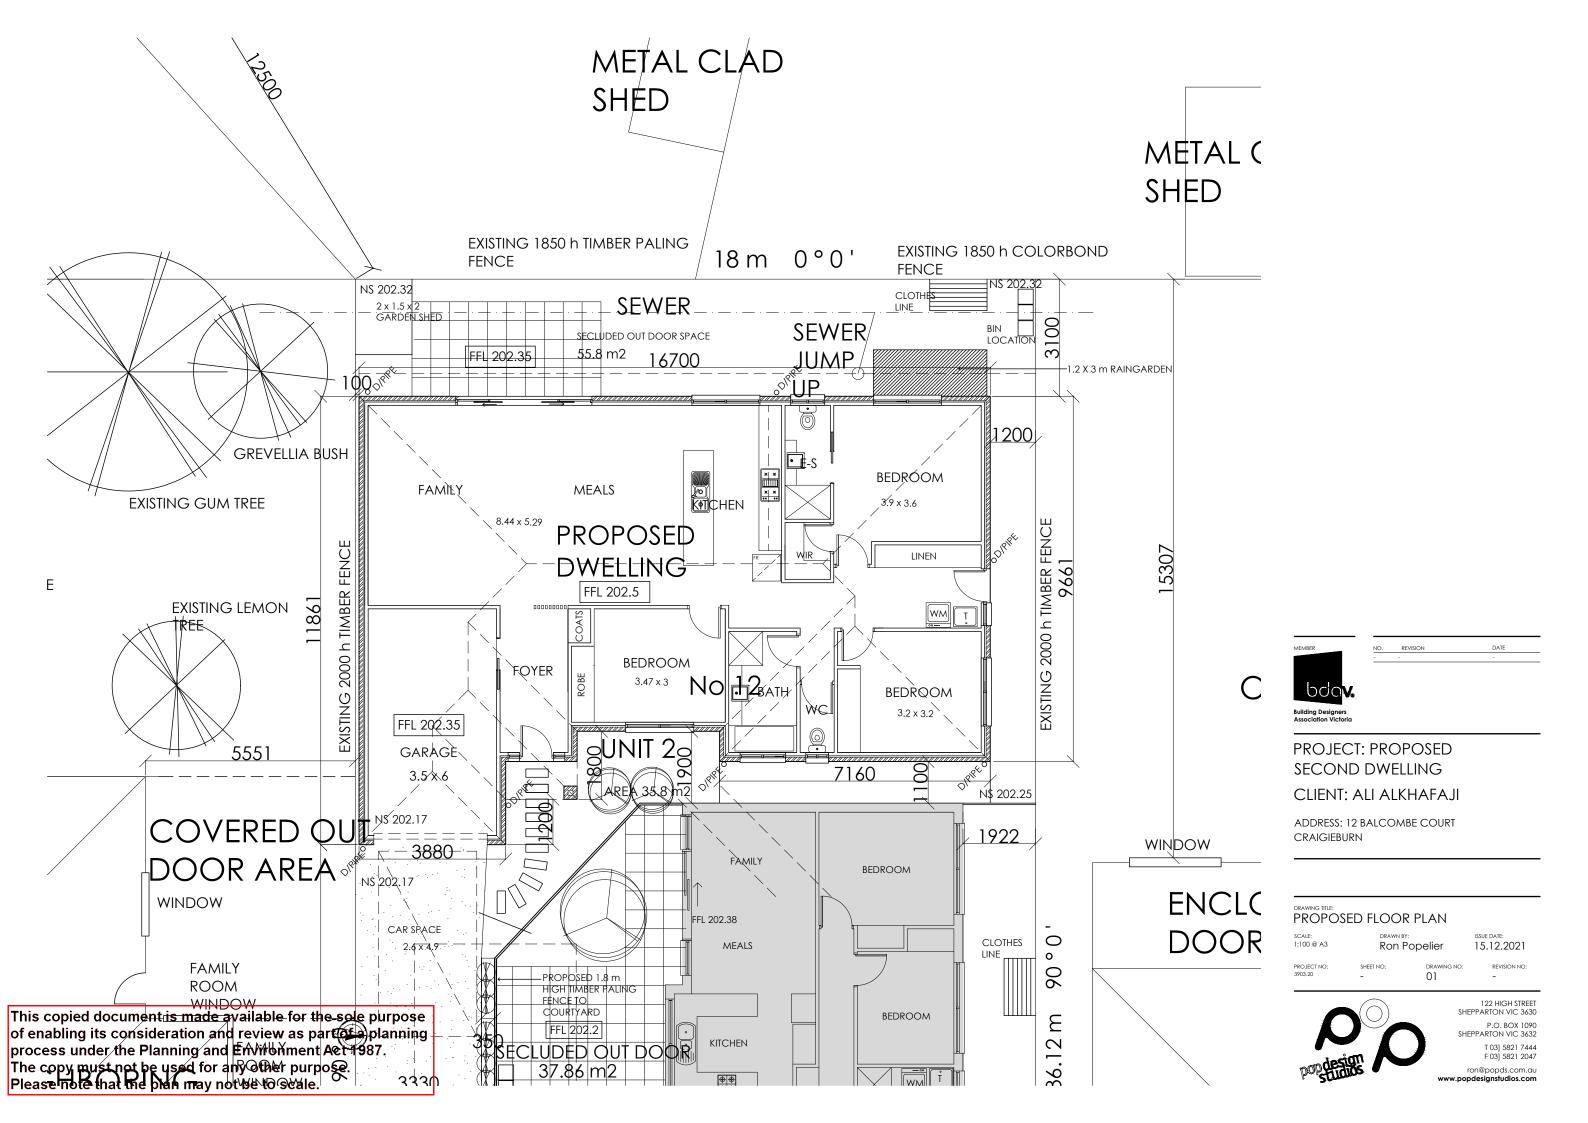
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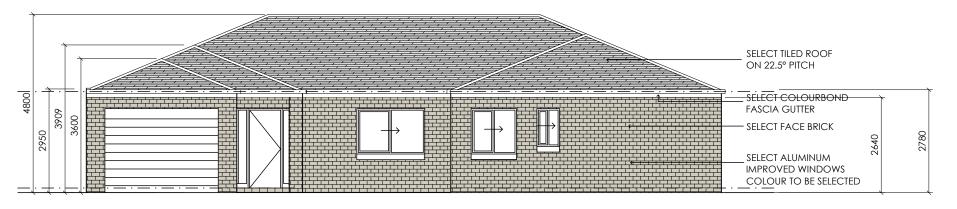
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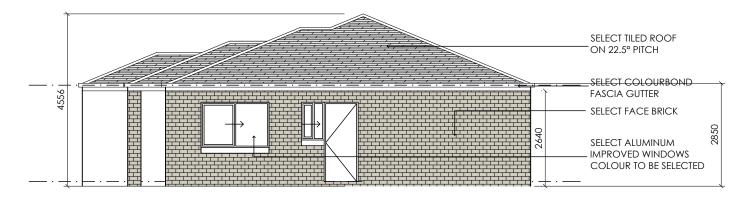


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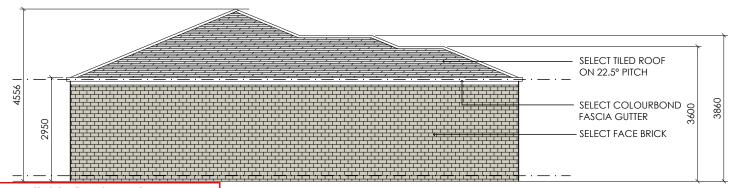
EAST ELEVATION



NORTH ELEVATION



WEST ELEVATION



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CLIENT: ALI ALKHAFAJI

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PROPOSED ELEVATIONS

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ISSUE DATE: 15.12.2021


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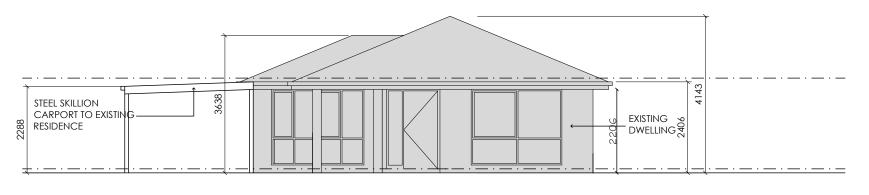
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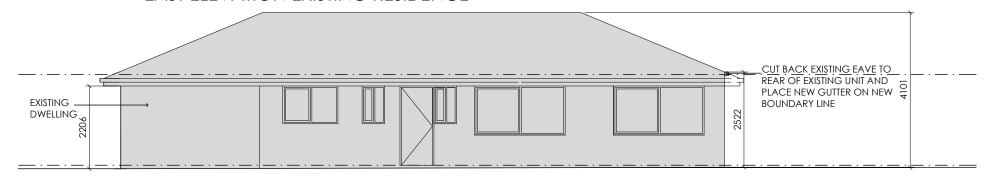


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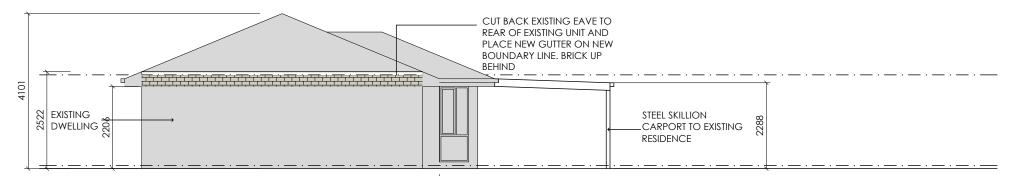





EAST ELEVATION EXISTING RESIDENCE

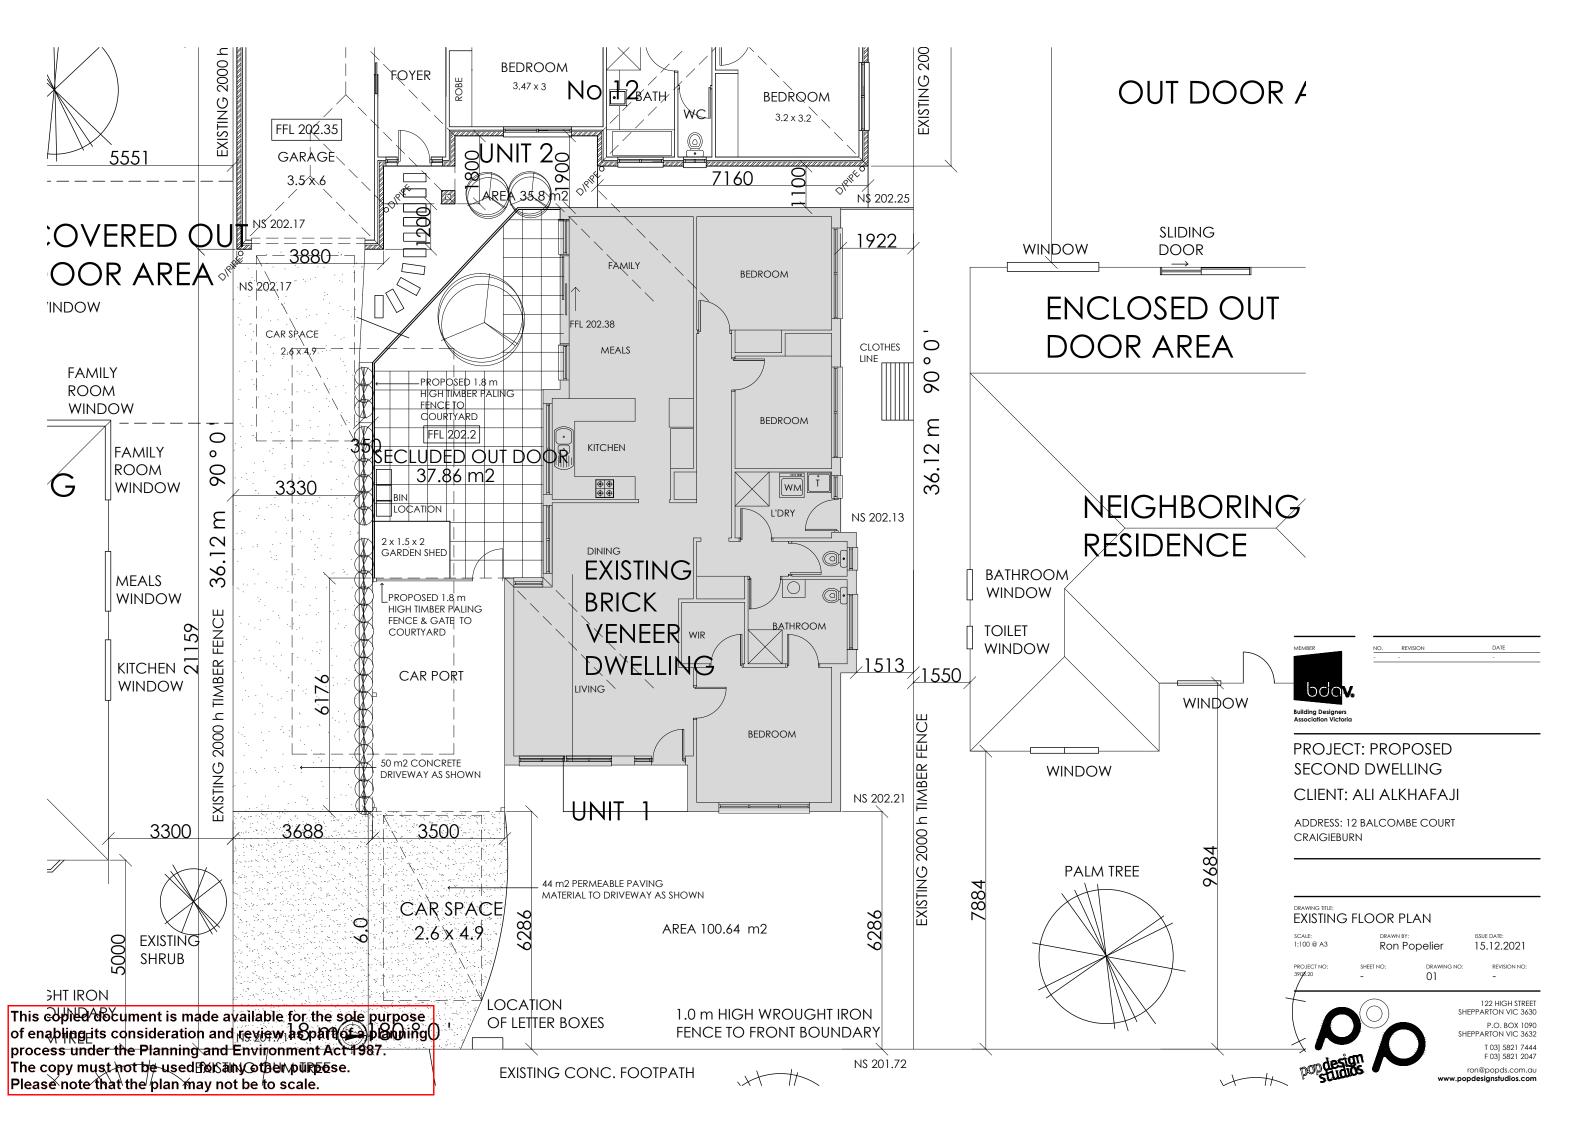

NORTH ELEVATION EXISTING RESIDENCE



WEST ELEVATION EXISTING RESIDENCE

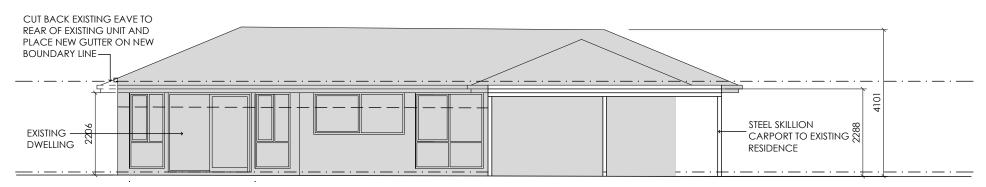

SOUTH ELEVATION EXISTING RESIDENCE

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ADDRESS: 12 BALCOMBE COURT CRAIGIEBURN

DRAWING TITLE: ELEVATIONS EXISTING BUILDING

Ron Popelier

15.12.2021

01

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PROPOSED NEIGHBORHOOD **ELEVATION**

ISSUE DATE: 15.12.2021 Ron Popelier

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Melbourne STORM Rating Report

TransactionID: 1258423 **HUME** Municipality: Rainfall Station: **HUME**

Address: 12 Balcombe Court

Craigieburn

VIC


Nadir Yonan Assessor:

Development Type: Residential - Multiunit

Allotment Site (m2): 360.00 STORM Rating %: 100

Description	Impervious Area (m2)	Treatment Type	Treatment Area/Volume (m2 or L)	Occupants / Number Of Bedrooms	Treatment %	Tank Water Supply Reliability (%)
Proposed Unit	172.00	Raingarden 100mm	3.60	0	128.50	0.00
Driveway	50.00	None	0.00	0	0.00	0.00

Program Version:

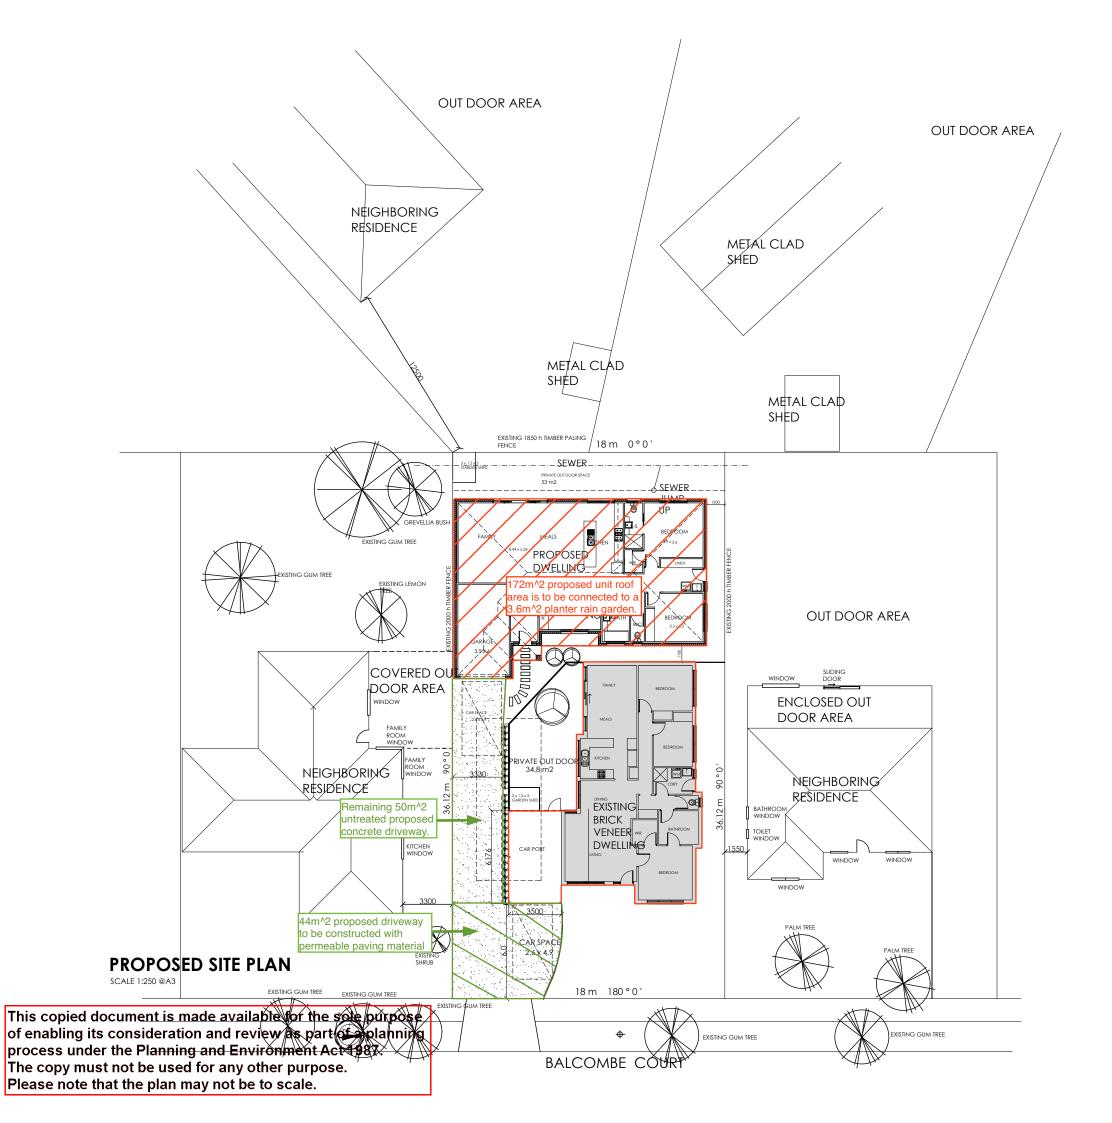



REVISION DATE

PROJECT: PROPOSED SECOND DWELLING CLIENT: ALI ALKHAFAJI

ADDRESS: 12 BALCOMBE COURT CRAIGIEBURN

DRAWING TITLE: PROPOSED SITE PLAN

SCALE: 1:250 @ A3 DRAWN BY: Ron Popelier ISSUE DATE: 26.10.2021

PROJECT NO:

SHEET NO

DRAWING NO:



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